

DATE:

August 12, 2025

TO:

Plan Holders Contractors FROM:

Jenna Richardson 918-596-9637 jennarichardson@cityoftulsa.org

## **EMAIL TRANSMITTAL**

ADDENDUM NO. 3

PROJECT NO. SW-23-01-01 STORMWATER MAINTENANCE AND OPERATIONS BUILDING

K K K

Number of pages: 32

All addenda to the contract documents should be denoted on the last page of the Proposal in the space provided.

Thank you, Contract Administration





DATE: August 14, 2025

# TO PROJECT NO. SW-23-01-01 STORMWATER MAINTENANCE AND OPERATIONS BUILDING

ADDENDUM NO. 3

This Addendum No. 3 consisting of twenty (20) items and fourteen (14) questions and answers, submitted by BKL, Inc., is hereby made a part of the Contract Documents to the same extent as though it were originally included therein and shall supersede anything contained in the Plans and Specifications with which it might conflict. All addenda to the contract documents should be denoted on the last page of the Proposal in the space provided.

This Addendum No. 3 consists of the following:

- The attached documents list the detailed items that have been modified in Addendum No. 3. These documents shall be inclusive and apply to this project.
- Delete the existing bid proposal form in its entirety and replace with the revised Bid Proposal located at: <a href="https://www.cityoftulsa.org/government/departments/public-works/engineering-services/construction-bids/">https://www.cityoftulsa.org/government/departments/public-works/engineering-services/construction-bids/</a>. It is Bidder's responsibility to download the revised Bid Proposal.

All other provisions of the Plans and Specifications shall remain in full force and effect.

**CITY OF TULSA** 

) home of the

Eric Lee

HAS/TGP/BC/JR/kt





# ADDENDUM NO. 03 Stormwater Maintenance and Operations Building SW23-01-01

August 14 2025

#### **NOTICE TO BIDDERS**

This Addendum is issued to all registered plan holders pursuant to the Instructions to Bidders and Conditions of the Contract. This Addendum serves to clarify, revise, and supersede information in the Project Manual, Drawings, and previously issued Addenda. Portions of the Addendum affecting the Contract Documents will be incorporated into the Contract by enumeration of the Addendum in the Owner/Contractor Agreement. The Bidder shall acknowledge receipt of this Addendum in the appropriate space on the Bid Form.

#### **CHANGES/CLARIFICATIONS TO PROJECT MANUAL**

1. Specification 102600 Wall and Door Protection

Add new specification 102600 in its entirety. Refer attached.

2. Specification 064100 Architectural Casework

Omit paragraph 3.4 from specification 064100 in its entirety.

3. Specification 133419 Metal Building Systems

Add "Steel Tech Building Systems" to section 2.3, paragraph A.

4. Specification 211316 Dry-Pipe Sprinkler Systems

**Omit** sections 2.06 Dry Sprinkler System Nitrogen Generator with Purge/Vent, 2.07 Pre-action Sprinkler System Nitrogen Generator with Purge/Vent and remaining references to Nitrogen.

5. Specification 265200 Solid State Lighting

Add Smith Lighting Sales as an approved vendor.

#### **CHANGES/CLARIFICATIONS TO DRAWINGS**

1. Sheet G0-03

Revise pay item 10 to read "NOT USED".

Revise the quantity on pay item 89 from "4,252" SF to "3,828" SF.

Add line below pay item 90 to ready "|90B| 095123 | 9.ACT3.2 – ACOUSTICAL CEILING TILE AND GRID (HIGH HUMIDITY) | 1,7 | SF | 427".

2. Sheet G0-04

Revise pay item 232 to a quantity of two (2).

Revise the following line below line 197 " | 197B | 265200 / 098436 | 40'-0" CEILING BAFFLES -MATCH MATERIAL AND SIZE OF PENDANT LIGHT P40 | 1 | EA | 8 |"

#### 3. Sheet A4-02

Revise the word "Quartz" to "Solid Surface (SDSF)"

#### 4. Sheet A5-01

Revise the word "Quartz" to "Solid Surface (SDSF)"

#### 5. Sheet A5-02

Revise the word "Quartz" to "Solid Surface (SDSF)"

#### 6. Sheet A5-05, Detail 6

Revise the word "Quartz" to "Solid Surface (SDSF)"

#### 7. Sheet A7-01

Revise the Ceiling Finish in room 151 LAB to ACT3.2

#### 8. Sheet A7-03

Add the following text to Keynote 6.LIP "1/2" OVERHANG, TYPICAL"

Revise "SDSF" under the PLASTIC LAMINATE heading to read "SDSF/RRV".

Revise ACOUSTICAL CEILING TILES AS FOLLOWS: "ACT1" to read "ACT1.2", "ACT2" to read "ACT2.2", and "ACT3" to read "ACT3.2".

Add the following item to the finish legend:

### ACOUSTICAL BAFFLE

#### ACOUSTICAL CEILING BAFFLE

MANUF: Neo Ray
DESCRIPTION: Ceiling Baffles

SPECIFICATION: 265200 / 098436

Match material and size of light fixture P40 LOCATION: OPEN OFFICE

#### 9. Sheet E2-02, Electrical Power Plan - South

Add keynote #2 "PROVIDE WATERPROOF WHILE IN-USE COVER FOR DATA".

Add keynote at exterior data location in wash bay.

#### 10. Sheet E2-03, Electrical Power - North

Modify microwave receptacle to GFCI in Break Room 108 per attached drawings.

**Modify** location of exterior receptacle by overhead door per attached drawings.

Modify location of undercounter fridge receptacle in Lactation Room 107 per attached drawings.

#### 11. Sheet E2-11, Electrical Systems Plan

Add access control per Door Schedule.

12. Sheet E4-01, Enlarged Electrical Plans

Provided clarification of annunciator panel conduit routing per attached drawings.

Provided clarification to generator panel circuiting per attached drawings.

13. Sheet E5-01, Electrical Details

Added 4" housekeeping pad for MDP.

14. Sheet E6-01, Electrical Schedules

**Modify** breaker for range to include GFCI protection per attached drawings.

Add keynote at exterior data location in wash bay per attached drawings.

15. Sheet E6-03, Panel Schedules

Modify fixtures S4, S4E, and S8 to be surface mounted.

#### ADDITIONAL QUESTIONS/RESPONSES

Q: Can the QCP requirements be removed from 064100 Architectural Casework?

A: Yes, this requirement has been removed from the specifications.

Q: Can we substitute the 1.125" thick shelves and 1.5" thick cabinet bottoms for 0.75" material?

A: The cabinet bottom can be 3/4" with a  $1\,1/2$ " front lip. The  $1\,1/8$ " adjustable shelf can be 3/4" shelf with a  $1\,1/8$ " to  $1\,1/2$ " front lip.

Q: Civil Pay note 105 states: "EXISTING AGGREGATE BASE MATERIAL ON-SITE MUST BE APPROVED BY ENGINEER TO BE UTILIZED FOR SOUTH DRIVE AGGREGATE BASE, TYPE A. APPROVED EXISTING AGGREGATE BASE MATERIAL ON-SITE MUST BE USED PRIOR TO WEST PARKING LOT.ANY MATERIAL. ITEM MAY BE ENTIRELY UNDERRUN." What does this statement mean? If existing agg base is approved for use, what pay item will be utilized for the removal and placement of it?

A: Use the existing gravel on site in place of Aggregate Base, Type A. The pay quantity in the summary sheets is the estimated amount needed to construct the parking lots, drives and building slab. Contractors should bid as if the existing aggregate base is nonexistent. This pay quantity can be reduced if utilizing existing aggregate base during construction.

Q: What are the requirements for the building pad? How will it be quantified and paid for?

A: Please refer to the soils report, it has been included in addendum.

Q: Pay item 218 – Trees (2 Ea) - What species and size are these?

A: Contractors shall bid 2" caliper Chinese Pistache trees.

Q: Pay item 232 – Outlet Lateral Headwall has a quantity of 7 ea. There are only 2 of them found in the drawings.

A: The correct quantity is 2. Sheet G0-04 has been updated and attached to this addendum.

Q: We are finding reference to quartz countertops in the restrooms (12.RRV) but do not see that a quartz has been noted on the finish legend. Are the restrooms to get quartz (12.RRV) or are they to get solid surface (12SDSF)? If they are to get quartz has one been selected?

A: Sheet A4-02, A5-01, A5-02: Revise the word "Quartz" to "Solid Surface (SDSF)"

Sheet A7-03: Change "SDSF" under the PLASTIC LAMINATE heading to read "SDSF/RRV".

Q: On elevation 6/A5-05 148 Coffee - West there is a notation for 6.LIP. The note at the top right hand of the page is blank. I am assuming this is noting a specific overhang for the countertop. Can you clarify what this is to be?

A: Sheet 6/A5-05: At keynote 6.LIP Add the following keynote text "1/2" OVERHANG, TYPICAL"

Q: There is a dumpster screen shown in the drawings. one reference is on sheet C1-13. I am not finding any info on what this is to be. Is this handled by the owner? If not, can you clarify what this screen wall is to be made from?

A: See Civil Pay Note 102 on Sheet G0-07 for requirements. The screen wall is a wood privacy fence surrounding the dumpster pad, provided and installed by the contractor.

Q: M8 is shown on the finish schedule. What is M8?

A: Refer to sheet G1-02, partition types. M8 is 8" burnished block.

Q: There does not appear to be gas shown going to RTU's 3 & 4 on the plans. Is this correct?

A: Correct, these are cooling only units.

Q: There is a detail shown for Fire Dampers on M102, but no locations are shown in the plans for Fire Dampers. Are Fire Dampers needed, location?

A: Mechanical room #147 has rated walls. Refer to detail 1/M1-02 near column 4B.

Q: Instead of installing a dry sprinkler system, can the fire suppression contractor install dry sidewalls or an antifreeze loop over the canopies?

A: Dry sidewalls are acceptable as long as proper coverage can be achieved. Antifreeze loops will not be approved.

Q: On the unit pricing bid sheet, Line # 10 notes 231 SF of 6" CMU. I am unable to locate the 6" CMU on the plans. Can you clarify where this is?

A: The 6" is currently not in plans and will be deleted from the bid form and pay quantity sheets.

#### **ATTACHMENTS**

Sheet G0-03

Sheet G0-04

Sheet E2-02

Sheet E2-03

Sheet E2-11

Sheet E4-01

Sheet E5-01

Sheet E6-01

Sheet E6-03

Specification 102600 Wall and Door Protection

Substitution Request Rejected – Lakewood Cabinetry, IPB Core Material

Substitution Request Approved as Noted - Smith Lighting Sales, Inc., All

Substitution Request Approved as Noted - Steel Tech Building Systems, Metal Building Supplier

Substitution Request Rejected – Steel Tech Building Systems, 24 ga. Metal Roof & Wall Panels

**END** 

#### **ELECTRONIC BID PROPOSAL INSTRUCTIONS - EXCEL SPREADSHEET**

#### STORMWATER MAINTENANCE AND OPERATIONS BUILDING PROJECT NO. SW23-01-01

#### Please read the following instructions carefully.

- 1. After opening this file re-save it as your company's name.
- 2. Open the BID FORM Sheet from the tabs below.
- 3. Input the unit price of the appropriate pay item in the cells highlighted in blue.
- Review all data input and check calculations to ensure accuracy of Bid.
   Print 1hardcopy of the "PROPOSAL" tab, BID FORM and the "SIGNATURE PAGE" tab.
- 6. Complete and sign the "Signature Page" document.
- 6. Submit hardcopy and electronic disk with Contract Documents and Specifications for Bid opening date.

#### AGREEMENT FOR USING ELECTRONIC BID PROPOSAL

By and Between: BKL, Inc., (ENGINEER) and RECIPIENT. The enclosed electronic media is provided pursuant to your request and is for your limited use in connection with your submittal of Bid Proposal for Project No. SW23-01-01. In no event shall the information be used for any other purpose or be released to third parties without the written consent of the ENGINEER. In the event of a discrepancy between the hard copy and this electronic media at delivery or in the future, the hard copy shall govern. ENGINEER hereby disclaims any and all liability for the consequences from use of the electronic media and makes no warranty or guarantee of accuracy. RECIPIENT shall assume full responsibility for the uses and consequences of the electronic media. It is agreed that ENGINEER has and retains ownership of the electronic media. ENGINEER does not warrant or guarantee that the electronic data is compatible with RECIPIENT'S computer hardware or software, and ENGINEER'S responsibility for the electronic media is limited to replacement of defective media for a period of thirty (30) days after delivery to RECIPIENT. !!! By opening and using this FILE, You AGREE to these TERMS AND CONDITIONS!!!

### Stormwater Maintenance and Operations Building PROJECT NO: SW23-01-01

TO: HONORABLE MAYOR CITY OF TULSA, OKLAHOMA

THE UNDERSIGNED BIDDER, having carefully examined the drawings, specifications, and other Contract Documents of the above project presently on file in the City Clerk, City of Tulsa Oklahoma:

CERTIFIES THAT he has inspected the site of the proposed work and has full knowledge of the extent and character of the work involved, construction difficulties that may be encountered, and materials necessary for construction, class and type of excavation, and all other factors affecting or which may be affected by the specified work; and

CERTIFIES THAT he has not entered into collusion with any other bidder or prospective bidder relative to the project and/or bid: and

HEREBY PROPOSES: to enter into a contract to provide all necessary labor, materials, equipment and tools to completely construct and finish all the work required by the Contract Documents hereto attached and other documents referred to therein: to complete said work within **730** calendar days after the work order is issued; and to accept in full payment therefore the amount set forth below for all work actually performed as computed by the Engineer as set forth in the Contract.

#### **Basis of Award**

IT SHOULD BE NOTED THAT THE LOWEST RESPONSIBLE BID SHALL BE DETERMINED BY THE TOTAL BASE BID PLUS ADDITIVE ALTERNATES NO.1 THRU NO. 6. THE ITEMS IN ADDITIVE ALTERNATES NO.1 THRU NO. 6 MAY OR MAY NOT BE INCLUDED IN THE CONTRACT AWARD AT THE SOLE DISCRETION OF THE CITY OF TULSA. ANY PROPOSAL SUBMITTED WITH THE ADDITIVE ALTERNATE NO.1 THRU NO. 6 INCOMPLETE SHALL BE CONSIDERED NON-RESPONSIVE

Note: - Item numbers omitted are not a part of the Contract.

					DATA INPUT	
BID ITEM	SPEC NO.	DESCRIPTION	UNIT	QTY	UNIT PRICE	TOTAL EACH ITEM
	50.4					
1 2	DIV 1 012100	GENERAL REQUIREMENTS AND MOBILIZATION OWNERS ALLOWANCE	LSUM	170000	6 4.00	£170,000,00
3	033000	CONCRETE SLAB AND SLAB EDGE	CY	170000 411	\$ 1.00	\$170,000.00
4	032000/033000	ELEVATED CONCRETE SLAB, REINFORCED	CY	15		
5	032000/033000	REINFORCED CONCRETE FOOTINGS	CY	41		
6	033543	SCONC - SEALED CONCRETE	SF	1358		
7	033543	PCONC1 - POLISHED CONCRETE FINISHING	SF	8201		
8	042200	M8 - 8" BURNISHED BLOCK - FULLY GROUTED	SF	1176		
9	042200	M8 - 8" BURNISHED BLOCK	SF	1386		
11	042200 042613	NOT USED M4 - 4" BURNISHED BLOCK	- SF	357		
12	051213	STEEL CANOPY STRUCTURE	LB	14430		
13	064100	WD - WOOD BASE	LF	328		
14	064100	WD - CHAIRRAIL	LF	546		
15	061000	PLYWOOD AT MECH ROOM	SF	361		
16	064116	6.BSINK SINK BASE CABINET - 36x34x24	EA	3		
17	064116	6.BWKSFADA-ADA WORKSURFACE BASE CABINET - 30x34x24	EA	1		
18 19	064116 064116	6.BWKSF - WORKSURFACE BASE CABINET - 36x34x24	EA	3		
20	064116	6.BTRSH - TRASH BASE CABINET WITH 8" COUNTER RING- 18x34x24 6.B2DRW - 2 DRAWER BASE CABINET - 24x34x24	EA EA	3		
21	064116	6.B3DRW - 3 DRAWER BASE CABINET - 18x34x24	EA	2		
22	064116	6.B3DRW - 3 DRAWER BASE CABINET - 27x34x24	EA	1		
23	064116	6.B3DRW - 3 DRAWER BASE CABINET - 28x34x24	EA	1		
24	064116	6.B3DRW - 3 DRAWER BASE CABINET - 15x30x24	EA	2		
25	064116	6.B3DRW - 3 DRAWER BASE CABINET - 30x24x24	EA	2		
26	064116	6.B3DRW - 3 DRAWER BASE CABINET - 30x42x24	EA	2		
27 28	064116 064116	6.B1DRW2DR - 1 DRAWER + 1 DOOR BASE CABINET - 16x34x24	EA	1		
29	064116	6.B2DRW2DR - 2 DRAWER + 2 DOOR BASE CABINET - 24x34x24 6.B2DRW2DR - 2 DRAWER + 2 DOOR BASE CABINET - 27x34x24	EA EA	2		
30	064116	6.B2DRW2DR - 2 DRAWER + 2 DOOR BASE CABINET - 27/34/24	EA	6		
31	064116	6.B2DRW2DR - 2 DRAWER + 2 DOOR BASE CABINET - 32x34x24	EA	6		
32	064116	6.B2DRW2DR - 2 DRAWER + 2 DOOR BASE CABINET - 36x34x24	EA	5		
33		6.U2DR - 1 DOOR UPPER CABINETS - 16x30x15	EA	1		
34		6.U2DR - 1 DOOR UPPER CABINETS - 18x30x15	EA	2		
35		6.U2DR - 2 DOOR UPPER CABINETS - 24x30x15	EA	4		
36 37		6.U2DR - 2 DOOR UPPER CABINETS - 30x30x15	EA EA	2 6		
38		6.U2DR - 2 DOOR UPPER CABINETS - 32x30x15 6.U2DR - 2 DOOR UPPER CABINETS - 33x30x15	EA	2		
39		6.U2DR - 2 DOOR UPPER CABINETS - 35x30x15	EA	2		
40		6.U2DR - 2 DOOR UPPER CABINETS - 36x30x15	EA	2		
41		6.U2DR - 2 DOOR UPPER CABINETS - 36x24x15	EA	5		
42		6.UCSU - OPEN SHELF - 36x30x15	EA	2		
43		6.UCSU - OPEN SHELF CORNER UNIT - 30x30x15	EA	11		
44	064116	6.BM - BENCH UNIT 60"	EA	2		
45 46		6 BN - BENCH UNIT SIDE TABLE 6.RECDESK - RECEPTION DESK WITH TRANSACTION COUNTER	EA LF	3 14		
47		6.RECDESK - RECEPTION DESK	LF LF	5		
48		6.VAN - RESTROOM VANITY 84x32x22	EA	2		
49	064116	6.VAN - RESTROOM VANITY 36x32x22	EA	2		
50	064116	6 VAN - RESTROOM VANITY 33x32x22	EA	1		
51	072100	THERMAL INSULATION	SF	840		
52	075423	TPO ROOFING SYSTEM	SF	1890		
53	079200	JOINT SEALANTS	SYS	1		
54	007 100	TYPE A -36" WOOD DOOR, H.M. FRAME, AND HARDWARE	EA	32		
55		TYPE A -PAIR 36" H.M. DOORS, H.M. FRAME, AND HARDWARE	EA	4		
56	081113, 081416, 087100	TYPE A -PAIR 36" WOOD DOORS, H.M. FRAME, AND HARDWARE	EA	6		
57	081113, 087100, 088000	TYPE B - H.M. DOOR, H.M. FRAME, AND HARDWARE - W/LITE	EA	9		
58	094113 097100	FEMA DOOR, H.M. FRAME, AND HARDWARE	EA	2		
59	088000	PAIR AL FRAME DOOR WITH GLASS, AL FRAME, AND HARDWARE	EA	3		
60		ALUM. STOREFRONT AND GLAZING	SF FA	962		
61 62		OVERHEAD SECTIONAL DOOR P1 - PARTITION	EA SF	1327		
63		P1A - PARTITION	SF	1327 6573		
	302210/002000		U.	5575		

1	T		·		-	19
64		P1AF - PARTITION	SF	4526		
65	092216/092900	P1F - PARTITION	SF	409		
66	092216/092900	P2 - PARTITION	SF	2093		
67	092216/092900	P2A - PARTITION	SF	305		
68	092216/092900	P3FT - PARTITION	SF	762		
69	092216/092900	P4TT - PARTITION	SF	265		
70	092216/092900	P5A - PARTITION	SF	249		
71	092216/092900	P5AF - PARTITION	SF	1396		
72	092216/092900	P6 - PARTITION	SF	6286		
73	092216/092900	P6A - PARTITION	SF	642		
74	092216/092900	P6F - PARTITION	SF	1256		
75	092216/092900	P6AF - PARTITION	SF	42		
76	092216/092900	P7T - PARTITION	SF	34		
77	092216/092900	P7AT - PARTITION	SF	142		
78	092216/092900	P7TAF - PARTITION	SF	183		
79		P11AF - PARTITION	SF	432		
80	092216/092900	P12AF - PARTITION	SF	179		
81		GYP BD CEILINGS	SF	1374		
82	093013	9.CT1 - PORCELAIN TILE (RESTROOM AND ENTRY FLOOR)	SF	1914		
83	093013	9.CT2 -PORCELAIN TILE (EXTERIOR TILE)	SF	1249		
84	093013	9.CT3 - PORCELAIN TILE (FLOORS)	SF	733		
85	093013	9.CT3 - PORCELAIN TILE (BASE)	SF	367		
86	093013	9.CT3 - PORCELAIN TILE (BISTROOM WALLS)	SF	1622		
87	093013	9.CT4 - PORCELAIN TILE (ACCENT AT RESTROOM WALLS)	SF	42		
88	093013	9.CT5 - PORCELAIN TILE (ACCENT AT RESTROOM WALLS)	SF	215		
89	095123	9.ACT1.2 - ACOUSTICAL CEILING TILES AND GRID	SF	3828		
90	095123	9.ACT2.2 - ACOUSTICAL CEILING TILES AND GRID  9.ACT2.2 - ACOUSTICAL CEILING TILES AND GRID (HIGH ACOUSTICS)	SF			
90B	095123	9.ACT3.2 - ACOUSTICAL CEILING TILES AND GRID (HIGH ACOUSTICS)  9.ACT3.2 - ACOUSTICAL CEILING TILES AND GRID (HIGH HUMIDITY)	10000	5659		
908	095123	9.RB1 - RUBBER BASE	SF	427		
91		200 A 100 A	LF	2989		
		9.CPT1 - CARPET TILES - OFFICES	SY	749		
93	097200	VINYL WALL COVERING AT MUD ROOM	SF	185		
94		9.AWP1, 9.AWP3, AND 9.AWP4 - ACOUSTICAL WALL PANELS	SF	1160		
95	098433	9.AWP2 - ACOUSTICAL WALL PANELS WITH WOOD SLATS	SF	2555		
96	099133	PAINT - EXTERIOR STEEL CANOPY	SYS	2		
97	099123	PAINT - GYP WALLS	SF	41738		
98	099123	PAINT - GYP CEILING	SF	1527		
99	099123	PAINT - EXP CEILING	SF	5567		
100	101100	10.MB9648 - MARKERBOARD 96" X 48"	EA	8	Ü.	
101		MARKERBOARD MARKER KITS	EA	4		
102	101416	PLAQUES	EA	1		
103	101419	BUILDING SIGNAGE - DIMENSIONAL LETTERS	SYS	1		
104	101419	DECORATIVE CONFERENCE ROOM SIGNAGE	SYS	1		
105	101423	EVACUATION SIGNAGE	EA	15		
106	101423	ROOM ID SIGNAGE	EA	13		***************************************
107	101423	ROOM ID SIGNAGE WITH INSERT	EA	23		
108	101423	CONFERENCE ROOM SIGNAGE	EA	8		
109	101423	RESTROOM SIGNAGE	EA	5		
110		REFUGE SIGNAGE	EA	2		
111		VINYL ON GLASS	EA	1		
112		10.TP - TOILET PARTITION (STANDARD)	EA	5		
113		10.TP - TOILET PARTITION (URINAL SCREEN)	EA	1		
114		10.TP - TOILET PARTITION (ORINAL GONELIN)	EA	4		
115	5.000,000,000,000,000,000,000,000,000,00	10.FP - FOLDING PARTITION WALL	SF	420		
116		10.WP - WALL AND DOOR PROTECTION	EA EA	35		
117		10.MU - MIRROR 72" WIDE X 48" TALL	EA	2		
118		10.MU - MIRROR 36" WIDE X 48" TALL	EA	2		
119	102800					
120		10.MU - MIRROR 33" WIDE X 48" TALL	EA EA	1		
121		10.DTPW - DUAL TOILET PAPER ROLL WITH SHELF 10.TSC - TOILET SEAT COVER	EA	10		
	102800 102800		EA	10		
122		10.SND - SANITARY NAPKIN WASTE	EA	6		
123		10.GB42 - 42" GRAB BAR	EA	5		
124		10.GB36 - 36" GRAB BAR	EA	5		
125		10.GB18 - 18" GRAB BAR	EA	6		
126		10.GBSHR - SHOWER GRAB BAR	EA	1		
127		10.SDW - SOAP DISPENSER	EA	10		
128		10.PTDW - PAPER TOWEL DISPENSER	EA	5		
129	102800	10.CPTD12 - RECESSED COMBO PAPER TOWEL DISPENSER AND 12	EA	5		
		GALLON WASTE CAN	5000000	88		
130		10.MHS - MOP AND BROOM HOLDER WITH SHELF	EA	2		
131		10.SRHC - 3' SHOWER ROD, HOOKS AND 4' (MIN) WIDE CURTAIN	EA	1		
132		10.RH - ROBE HOOK	EA	3		
133		10.CSS - CORNER SHOWER SHELF	EA	1		
134	102800	10.WSS - WALL MOUNTED FOLDING SHOWER SEAT	EA	10		
135		10.CG - METAL CORNER GUARD	EA	47		
136	105129	10.LK - PHENOLIC LOCKERS (15W X 18D X 72H)	EA	3		
					Secretary Colors Comment of the Color	A constitution of the same and a constitution of the same and the same

I 127	L 104412/104416	40 FEC. FIDE EXTINGUIGHEDS AND CARINETS	Ι ΓΛ	T .	1	r
137 138	104413/104416 104413/104416	10.FEC - FIRE EXTINGUISHERS AND CABINETS 10.AED - AUTOMATIC EMERGENCY DEFIBRILLATOR	EA EA	6		
139	122413	WT3 - ROLLER WINDOW SHADES 48X48	EA	16		
140	122413	WT4 - ROLLER WINDOW SHADES 48X86	EA	5		
141	122413	WT5 - ROLLER WINDOW SHADES (3) 48X48 GROUPED TOGETHER	EA	2		
142	122413	WT6 - ROLLER WINDOW SHADES 36X48	EA	1		
		12.SDSF - SOLID SURFACE COUNTERTOP - 25" DEEP WITH 1.5 INCH				
143	123661	EDGE	SF	245		
144	123661	12.SDSF - SOLID SURFACE VANITY - 22" DEEP WITH 1.5 INCH EDGE	SF	44		
145	123661	12.SDSF - SOLID SURFACE TRANSACTION - 12" DEEP WITH 1.5 INCH	SF	14		
	C1V-0170-0100	EDGE				
146	123661	12.SDSF - SOLID SURFACE BACK SPLASH - 4"	SF	14		
147	133419	NEW PRE-ENGINEERED METAL BUILDING	SF	19678		
148	211313, 211316	FIRE SUPPRESSION	SF	19678		
149 150	224200 224200	WC-1 FLOOR MOUNTED FLUSH VALVE WATER CLOSET (ADA) WC-2 FLOOR MOUNTED FLUSH VALVE WATER CLOSET	EA	5		
151	224200	UR-1 URINAL	EA EA	5 3		
152	224200	LAV-1 - DROP IN LAVORATORY	EA	7		
153	224200	SK-1 DOUBLE BOWL DROP-IN SINK	EA	1		
154	224200	SK-4 SINGLE BOWL DROP-IN SINK (ADA)	EA	2		
155	224200	EW-1 -EYE WASH STATION	EA	1		
156	224200	MSB-1 MOP SERVICE BASIN	EA	2		
157	224200	SH-1 SHOWER	EA	1		
158	224200	EWC-1 ELECTRIC WATER COOLER (ADA) SINGLE	EA	1		
159	224200	EWC-2 ELECTRIC WATER COOLER (ADA)	EA	1		
160	224200	IMB-1 ICE MAKER BOX	EA	7		
161	224200	FPHB-1 FREEZEPROOF WALL HYDRANT	EA	6		
162	224200	FPHB-2 FREEZEPROOF WALL HYDRANT (DUAL TEMP)	EA	1		
163	224200	FPRH-1 FREEZEPROOF ROOF HYDRANT	EA	1		
164	223400	WH-1 WATER HEATER	EA	1		
165	223400	WH-2 WATER HEATER	EA	1		
166	221116	CIRC PUMP SYSTEM AND PIPING	EA	2		
167	221116	DCV-1 DOUBLE CHECK VALVE BACKFLOW PREVENTER 3"	SYS	1		
168 169	221116 221316	DCV-2 DOUBLE CHECK VALVE BACKFLOW PREVENTER	SYS	1		
170	221316	YCO-1 YARD CLEANOUT WCO-1 WALL CLEANOUT	EA EA	2		
171	224200	FLOOR DRAIN	EA	16		
172	224200	FS-1 FLOOR SINK	EA	1		
173	224200	FCO-1 FLOOR CLEAN OUT	EA	4		
174	224200	TD-1 TRENCH DRAIN	EA	1		·
175	224200	OI-1 OIL INTERCEPTOR	EA	1		
176	221316	SANITARY PIPING	SYS	1		
177	221116	DOMESTIC PIPING	SYS	1		
178	221414	ROOF DRAIN SYSTEM	SYS	1		
179	230000	COMPLETE MECHANICAL SYSTEM	SYS	1		
180		A 2X4 RECESSED, 4000L	EA	66		
181	265200	AE 2X4 RECESSED, 4000L, INTERGRAL BATTERY	EA	19		
182	265200	B 2X2 RECESSED, 3200L	EA	33		
183	265200	BE 2X2 RECESSED, 3200L, INTEGRAL BATTERY	EA	5		
184		D4 4" LED DOWNLIGHT, 2000L	EA	14		
185	265200	D4E 4" LED DOWNLIGHT, 2000L, INTEGRAL BATTERY	EA	1		
186	265200	D6 6" LED DOWNLIGHT, 2500L	EA	35		
187 188	265200 265200	D6E 6" LED DOWNLIGHT, 2500L, INTEGRAL BATTERY EM 20W LED MULLION MOUNTED EMERGENCY FIXTURE	EA EA	23		
189	265200	F 8W LED SPOT LIGHT MOUNTED EMERGENCY FIXTURE  F 8W LED SPOT LIGHT MOUNTED DIRECTLY TO JUNCTION BOX.	EA	2		
190	265200	L1 5.6W/FT RECESSED LINEAR FIXTURE (7' 2-1/4" LENGTH)	EA	2		
191	265200	L2 5.6W/FT RECESSED LINEAR FIXTURE (7 2-1/4" LENGTH)	EA	2		
0.0000000	101111-1011-1007-1-1-1	L3E 5.6W/FT RECESSED LINEAR FIXTURE (23' 3/8" LENGTH). PROVIDE (3)	100000			
192	265200	EM AS INDICATED ON PLANS.	EA	2		
193	265200	P6 6' LED UP/DOWN PENDANT FIXTURE	EA	1		
194	265200	P8 8' LED UP/DOWN PENDANT FIXTURE	EA	1		
195		P20 20' LED PENDANT FIXTURE, 675 LM/FT DOWN, 530 LM/FT UP, 20'				
190	265200	AIRCRAFT CABLE MOUNT, INTEGRAL BATTERIES	EA	4		
196	265200	P24 24' LED PENDANT FIXTURE, 675 LM/FT DOWN, 530 LM/FT UP, 20'	EA	4		
100	200200	AIRCRAFT CABLE MOUNT, INTEGRAL BATTERIES		7		
197	265200	P40 40' LED PENDANT FIXTURE, 675 LM/FT DOWN, 530 LM/FT UP, 20'	EA	10		
		AIRCRAFT CABLE MOUNT, INTEGRAL BATTERIES PER PLANS.	<del></del>	1.5		
197B	265200 / 098436	40'-0" CEILING BAFFLES - MATCH MATERIAL AND SIZE OF PENDANT	EA	8		
\$25387KS		LIGHT P40.	100.0000	200		
198	265200	S4 4' SURFACE MOUNTED LINEAR FIXTURE, 795LM/FT	EA	5		
199 200	265200 265200	S4E 4' SURFACE MOUNTED LINEAR FIXTURE, 795LM/FT, EM S8 8' SURFACE MOUNTED LINEAR FIXTURE, 795LM/FT	EA EA	5		
200	265200 265200	St 4' LED STRIP LIGHT 4100L (6.5W/FT)	EA EA	10		
202	265200	STE 4' LED STRIP LIGHT 4100L (6.5VWFT) STE 4' LED STRIP LIGHT 4100L, INTEGRAL BATTERY	EA	3		
203	265200	T-18000 LUMEN LED POLE LIGHT (PROVIDE 20' POLE AND 3' POLE BASE)	EA	15		

1 204	1 005000	W WALL MOUNTED LED ENTINE MITH WALL MOUNT DRACKET	T 54		1	1
204	265200	W WALL MOUNTED LED FIXTURE WITH WALL MOUNT BRACKET.	EA EA	14		
	265200	WE WALL MOUNTED LED FIXTURE WITH WALL MOUNT BRACKET	EA	2		
206	265200	WL 22' WALL WASH LED FIXTURE, 795 LM/FT	EA	1		
207	265200	WW 4" LED WALL WASH DOWNLIGHT, 1000L	EA	3		
208	265200	XC1 LED RED EXIT SIGN, SINGLE FACE, CEILING MOUNT	EA	5		
209	265200	XC2 LED RED EXIT SIGN, DOUBLE FACE, CEILING MOUNT	EA	4		
210	265200	XW1 LED RED EXIT SIGN, SINGLE FACE, WALL MOUNT	EA	8		
211	260000	POWER SYSTEM	SYS	1		
212	283111	FIRE ALARM SYSTEM	SF	19678		
213	202(A)	UNCLASSIFIED EXCAVATION	CY	2205		
214			CY			
	202(D)	UNCLASSIFIED BORROW		1315		
215	205(A)	TYPE A-SALVAGED TOPSOIL	CY	274		
216	220	SWPPP DOCUMENTATION	LSUM	1		
217	230(A)	SOLID SLAB SODDING	SY	2445		
218	231(A)	TREES	EA	2		
219	240(A)	REMOVING TREES 6" TO 12" IN DIAMETER	EA	2		
220	303(A)	AGGREGATE BASE TYPE A	CY	1257		
221	310(B)	SUBGRADE, METHOD B	SY	4092		
222	325	SEPARATOR FABRIC	SY	4223		
223	414(B)	DOWEL JOINTED P.C.C. PAVT. (PLACEMENT)	SY	3595		
224			CY	601		
	414(G)	P.C. CONCRETE FOR PAVEMENT				
225	601(A)	TYPE I PLAIN RIPRAP	TON	6		
226	609	(PL) PARKING BLOCK	EA	54		
227	609(A)	COMBINED CURB AND GUTTER (6" BARRIER)	LF	602		
228	610(A)	4" CONCRETE SIDEWALK	SY	839		
229	613(A)	24" REINFORCED CONCRETE PIPE (RCP), COMPLETE IN PLACE	LF	42		
230	613(I)	8" NON-PERF.PIPE UNDERDRAIN RND.	LF	421		
231	613(L)	24" PREFAB. CULVERT END SEC., ROUND	EA	2		
232	613(Q)	OUTLET LATERAL HEADWALL	EA	2		
233	619(B)	REMOVAL OF FENCE	LF	10		
234	619(B)	REMOVAL OF ASPHALT PAVEMENT	SY	1229		
235	619(B)	REMOVAL OF EXISTING STRUCTURES	EA	1		
236	619(B)	REMOVAL OF EXISTING PIPE	LF	49		
237	624	(PL) WOOD PRIVACY FENCE W/ GATE	LF	39		
238	850(A)	SHEET ALUMINUM SIGNS	SF	7		
239	851(C)	1.5" SQUARE TUBE POST	LF	40		
240	851(C)	2" SQUARE TUBE POST	LF	10		
241						
	856(A)	TRAFFIC STRIPE (PLASTIC)(4" WIDE)	LF	1334		
242	856(B)	TRAFFIC STRIPE (PLASTIC)(SYMBOLS)	EA	4		
243	SPECIAL	12"X12" LANDSCAPING AREA INLET	EA	1		
244	SPECIAL	DOWNSPOUT ADAPTER	EA	7		
245	SPECIAL	CURB RAMP	EA	2		
246	COT 309	6 INCH PVC AWWA C900 CLASS 200 DR-14 (RJ)	LF	140		
247	COT 312	6 INCH DUCTILE IRON SLEEVE (RJ)	EA	3		
248	COT 312	12 INCH DUCTILE IRON SLEEVE (RJ)	EA	2		
249	COT 312	6 INCH X 3 INCH DUCTILE IRON TEE (RJ)	EA	1		
250	COT 312	12 INCH X 6 INCH DUCTILE IRON TEE (RJ)	EA	1		
251	COT 313	6" SANITARY SEWER LINE	LF	113		
252	COT 315	3 INCH WATER SERVICE CONNECTION (LONG)	EA	1		
253	COT 315	3 INCH COMPOUND WATER METER	EA	1		
254	COT 315	3 INCH WATER METER VAULT	EA	1		
255	COT 317	6 INCH GATE VALVE (RJ)	EA	1		
256	COT 318	VALVE BOX	EA	1		***************************************
257	SPECIAL	POWER SERVICE CONNECTION (4" CONDUIT)	LF	271		
258	019113	HVAC GENERAL COMMISSIONING	EA	1		
230	019113		EA			0470 000 00
		TOTAL BASE BID				\$170,000.00
f						
ALTERNA	ATE 1					
300	032000/033000	REINFORCED CONCRETE GENERATOR PAD	CY	9		
301	263213.13	GENERATOR	EA	1		
301	200210.10					***************************************
		TOTAL ALTERNATE 1				
ALTERNA	ATE 2					
302	123553.19	OPEN SHELVING UNIT 42X85X18	EA	2		
303	123553.19	SINK BASE CABINET - 39x34x24	EA	1		
304	123553.19	SINK BASE CABINET - 36x34x24	EA	1		
305	123553.19	ACCESS PANEL	EA	2		
306						
	123553.19	2 DRAWER + 2 DOOR BASE CABINET - 30x34x24	EA	4		
		2 DRAWER + 2 DOOR BASE CABINET - 36x34x24	EA	3		
307	123553.19					
308	123553.19	4 DRAWER BASE CABINET - 15x34x24	EA	2		
	123553.19 123553.19		EA EA	6		
308	123553.19	4 DRAWER BASE CABINET - 15x34x24				
308 309	123553.19 123553.19 123553.19	4 DRAWER BASE CABINET - 15x34x24 4 DRAWER BASE CABINET - 18x34x24 CORNER BASE CABINET WITH LAZY SUZAN - APPOX 36x34x36	EA EA	6 1		
308 309 310 311	123553.19 123553.19 123553.19 123553.19	4 DRAWER BASE CABINET - 15x34x24 4 DRAWER BASE CABINET - 18x34x24 CORNER BASE CABINET WITH LAZY SUZAN - APPOX 36x34x36 OPEN BASE CABINET - 36X	EA EA EA	6 1 2		
308 309 310	123553.19 123553.19 123553.19	4 DRAWER BASE CABINET - 15x34x24 4 DRAWER BASE CABINET - 18x34x24 CORNER BASE CABINET WITH LAZY SUZAN - APPOX 36x34x36	EA EA	6 1		

044	100550 10	ODEN QUELE CODNED UNIT. ADDROV COVOS AS	T = .		1 1	
314	123553.19	OPEN SHELF CORNER UNIT - APPROX 36X30x15	EA	1		
315	123553.19	DRYING RACK - WITH TRAY 30X36	EA	1 -		
316 317	123553.19	ADJUSTABLE SHELVING	LF	5		
317	123553.19	36" DEEP RESIN COUNTERTOP WITH FRONT LIP	LF LF	11 24		
319	123553.19 123553.19	30" DEEP RESIN COUNTERTOP WITH FRONT LIP	LF LF	5		
320	123553.19	30" TO 36" TRANSITION RESIN COUNTERTOP AT CORNER 4" HIGH BACKSPLASH	LF	40		
321	123553.19	RESIN ISLAND COUNTERTOP WITH FRONT LIP - 49"	LF	9		
322	224200	SK-2 SINGLE BOWL DROP-IN SINK	EA	1		
323	224200	SK-3 SINGLE BOWL DROP-IN SINK (ADA)	EA	1		
324	224200	EWS-1 EYE WASH STATION	EA	1		
325	260000	ELECTRICAL POWER AT LAB	SYS	1		
326	115329	4' FUME HOOD SYSTEM WITH DUCTWORK	EA	1		
OLO	110020	TOTAL ALTERNATE 2				
		TO THE METERIAL E				
ALTERNAT	TE 3					
327	095123	9.ACT 2.2 - ACOUSTICAL CEILING TILES AND GRID (HIGH ACOUSTICS)	SF	5567		~
	000120	TOTAL ALTERNATE 3	U.	0001		
					_	
ALTERNAT	E 4					
328	202(A)	UNCLASSIFIED EXCAVATION	CY	1403		
329	202(D)	UNCLASSIFIED BORROW	CY	351		
330	205(A)	TYPE A-SALVAGED TOPSOIL	CY	26		
331	230(A)	SOLID SLAB SODDING	SY	232		
332	303(A)	AGGREGATE BASE TYPE A	CY	590		
333	310(B)	SUBGRADE, METHOD B	SY	3905		
334	325	SEPARATOR FABRIC	SY	3916		
335	411(C)	SUPERPAVE, TYPE S4 PG (64-22)	TON	401		
336	411(C)	SUPERPAVE, TYPE S3 PG (64-22)	TON	802		
337	601(A)	TYPE I PLAIN RIPRAP	TON	11		
338	609(A)	COMBINED CURB AND GUTTER (6" BARRIER)	LF	581		
339	611(G)	INLET CI DES. 2 (STD)	EA	2		
340	613(A)	18" REINFORCED CONCRETE PIPE (RCP), COMPLETE IN PLACE	LF	172		
341	613(L)	18" PREFAB. CULVERT END SEC., ROUND	EA	2		
342	850(A)	SHEET ALUMINUM SIGNS	SF	4		
343	851(C)	1.5" SQUARE TUBE POST	LF	20		
344	851(C)	2" SQUARE TUBE POST	LF	5		
345	856(A)	TRAFFIC STRIPE (PLASTIC)(4" WIDE)	LF	1846		
346	856(B)	TRAFFIC STRIPE (PLASTIC)(SYMBOLS)	EA	2		
347	SPECIAL	CURB RAMP	EA	1		
		TOTAL ALTERNATE 4				
LTERNAT						
348	113200	11.CM - COFFEE MAKER INSTALLATION	EA	5		
349	113200	11.DW - DISHWASHER (BREAKROOM AND LAB)	EA	2		
350	113200	11.IM - COUNTERTOP ICEMAKER	EA	1		
351	113200	11.MWC - MICROWAVE	EA	3		
352	113200	11.RANGE - RANGE AND RANGE HOOD	EA	1		
353	113200	11.REF1 - REFRIGERATOR - BREAKROOMS	EA	3		
354	113200	11.REF2 - REFRIGERATOR (LAB)	EA	2		
355	113200	11.REF3 - UNDERCOUNTER REFRIGERATOR (LACTATION ROOM)	EA	1		
356	113200	COUNTER TOP FREEZER (LAB)	EA	1		
		TOTAL ALTERNATE 5			L	
	T 0					
LTERNAT		Inco CALLON ACUADUM	·			
357	SPECIAL	300 GALLON AQUARIUM TOTAL ALTERNATE 6	EA	1		

BASE BID (ITEMS 1 - 258)		\$ 170,000.00
ADD ALT #1		\$ -
ADD ALT #2		
ADD ALT #4		<u> </u>
ADD ALT #4 ADD ALT #5		\$ - \$ - \$ - \$ - \$ -
ADD ALT #6		\$ -
BASE BID PLUS ADDITIVE ALTERNATES		\$ 170,000.00
Enclosed is a ( ) Bidder's Surety Bond, ( )	Certified Check, ( ) Cashier's Check for	
%		
which the City of Tulsa may retain or recover as lig	uidated damages in the event that the undersign	ed fails to enter into
contract for the work covered by this proposal., pro		
days, or within ninety (90) days if Federal funds are		
fails to execute said Contract and furnish the requir Documents within thirty (30) days after award of C		these Contract
Documents within thirty (30) days after award of C	ontract.	
Dated at Tulsa, Oklahoma, this day of _		
Respectfully submitted,		
(Complete legal name of co	ompany)	
, 1	1 32	
(State of Organizati	on)	
(otate or organization		
Ву:	ATTEST:	
Title:	Title: Corporate Secretory	
Printed Name:	Title: Corporate Secretary Printed Name:	
		(SEAL)
	Address:	_
	,	<u> </u>
Telephone Number:	Fax Number:	
By signing above the bidder acknowledges receipt of	t the following Addenda (give number and date	of each):

#### SECTION 102600 WALL AND DOOR PROTECTION

#### PART 1 - GENERAL

#### 1.1 SUMMARY

- A. Section Includes:
  - 1. Corner guards.

#### 1.2 ACTION SUBMITTALS

- A. Product Data: For each type of product.
  - Include construction details, material descriptions, impact strength, dimensions of individual components and profiles, and finishes.
- B. Samples for Initial Selection: For each type of impact-resistant wall-protection unit indicated, in each color and texture specified.
  - 1. Include Samples of accent strips and accessories to verify color selection.

### 1.3 CLOSEOUT SUBMITTALS

- A. Maintenance Data: For each type of wall and door protection product to include in maintenance manuals.
  - Include recommended methods and frequency of maintenance for maintaining best condition of plastic covers under anticipated traffic and use conditions.
     Include precautions against using cleaning materials and methods that may be detrimental to finishes and performance.

#### 1.4 QUALITY ASSURANCE

#### PART 2 - PRODUCTS

#### 2.1 SOURCE LIMITATIONS

A. Obtain wall- and door-protection products of each type from single source from single manufacturer.

#### 2.2 CORNER GUARDS

- A. Surface-Mounted, Metal Corner Guards: Fabricated as one piece from formed or extruded metal with formed edges; with 90- or 135-degree turn to match wall condition.
  - Basis-of-Design Product: Subject to compliance with requirements, provide Construction Specialties or an approved comparable product by one of the Stormwater Maintenance and Operations Building 06/06/2025

102600 - WALL AND DOOR PROTECTION

#### following:

- a. JL Industries; Activar Construction Products Group, Inc.
- b. Koroseal Interior Products, LLC

#### 2. Material:

- a. Extruded aluminum, minimum 0.0625 inch thick, with powder coded finish.
- 3. Wing Size: Nominal 2 by 2 inches.
- Corner Radius: 1/8 inch.
- 5. Mounting: Flat-head, countersunk screws through factory-drilled mounting holes.

#### 2.3 MATERIALS

- A. Fasteners: Aluminum, nonmagnetic stainless-steel, or other noncorrosive metal screws, bolts, and other fasteners compatible with items being fastened. Use security-type fasteners where exposed to view.
- B. Adhesive: As recommended by protection product manufacturer.

#### 2.4 FABRICATION

- A. Fabricate wall and door protection according to requirements indicated for design, performance, dimensions, and member sizes, including thicknesses of components.
- B. Factory Assembly: Assemble components in factory to greatest extent possible to minimize field assembly. Disassemble only as necessary for shipping and handling.
- C. Quality: Fabricate components with uniformly tight seams and joints and with exposed edges rolled. Provide surfaces free of wrinkles, chips, dents, uneven coloration, and other imperfections. Fabricate members and fittings to produce flush, smooth, and rigid hairline joints.

#### 2.5 FINISHES

- A. Protect finishes on exposed surfaces from damage by applying a strippable, temporary protective covering before shipping.
- B. Appearance of Finished Work: Noticeable variations in same piece are not acceptable. Variations in appearance of adjoining components are acceptable if they are within the range of approved Samples and are assembled or installed to minimize contrast.

#### PART 3 - EXECUTION

#### 3.1 EXAMINATION

- A. Examine substrates and wall areas, with Installer present, for compliance with requirements for installation tolerances and other conditions affecting performance of the Work.
- B. Examine walls to which wall and door protection will be attached for blocking, grounds,

Stormwater Maintenance and Operations Building 06/06/2025 102600 - WALL AND DOOR PROTECTION and other solid backing that have been installed in the locations required for secure attachment of support fasteners.

- 1. For wall and door protection attached with adhesive, verify compatibility with and suitability of substrates, including compatibility with existing finishes or primers.
- C. Proceed with installation only after unsatisfactory conditions have been corrected.

#### 3.2 PREPARATION

- A. Complete finishing operations, including painting, before installing wall and door protection.
- B. Before installation, clean substrate to remove dust, debris, and loose particles.

#### 3.3 INSTALLATION

A. Installation Quality: Install wall protection according to manufacturer's written instructions, level, plumb, and true to line without distortions. Do not use materials with chips, cracks, voids, stains, or other defects that might be visible in the finished Work.

#### 3.4 CLEANING

- A. Immediately after completion of installation, clean plastic covers and accessories using a standard ammonia-based household cleaning agent.
- B. Remove excess adhesive using methods and materials recommended in writing by manufacturer.

**END OF SECTION 102600** 

### CSI Form 1.5C

## **SUBSTITUTION** REQUEST (During the Bid Period)

Project: Stormwater Maintenance and Operations Building Substitution Request Number:	18-80ptes/107/28	SELFORESTICS.	and sympletic or sym	9/2011 1 C C C C C C C C C C C C C C C C C	STREET, LES THE SERVE OF LONG PROTECTION, THE PERSON WAS	arana managa	THE RESERVE OF THE PROPERTY OF		the Blu I criou)
To: Bobby Edwards - Ascend Commercial Builders  Date: 7/29/2025  A/E Project Number: SW23-01-01  Re: Contract For: Milwork  Specification Trite: Architectural Wood Casework Description: Panel core material  Article/Paragraph: 2.2 - B - 1 (Plans A6-01, A6-02)  Proposed Substitution: Substitute specified MDF core material in the specifications and casework detail pages for more economical IPB Manufacturer: Lakewood Cabinetry Address: 36775 S. Hwy 82 Langley, OK 74350 Phone: 918 - 782 - 2203  Attached data includes product description, specifications, drawings, photographs, and performance and test data adequate for evaluation of the request, applicable portions of the data are clearly identified.  Attached data also includes a description of changes to the Contract Documents that the proposed substitution will require for its proper installation.  The Undersigned certifies:  Proposed substitution has been fully investigated and determined to be equal or superior in all respects to specified product.  Same warranty will be furnished for proposed substitution as for specified product.  Same maintenance service and source of replacement parts, as applicable, is available.  Proposed substitution does not affect dimensions and functional clearances.  Payment will be made for changes to building design, including A/E design, detailing, and construction costs caused by the substitution.  Submitted by: Nathan Cassity  Medsa Camby  Telephone:  918 - 782 - 2203  APE's REVIEW AND ACTION  APE Lakewood Cabinetry, Inc.  Substitution approved - Make submittals in accordance with Specification Section 01 25 00 Substitution Procedures.  Substitution approved as noted - Make submittals in accordance with Specification Section 01 25 00 Substitution Procedures.  Substitution Reguest received too late - Use specified materials.  Substitution Reguest received too late - Use specified materials.  Date: 8/7/25	Project:	Storn	nwater M	aintenance and	Operations Building	Substitu	tion Request Number	:002	
A/E Project Number: _SW23-01-01  A/E Project Number: _SW23-01-01  Re:						From:	Lakewood Cabir	netry, Inc.	
Re:	To:	Bobb	y Edward	ds - Ascend Con	nmercial Builders	Date:	7/29/2025		
Re:							ject Number: SW23	3-01-01	
Section: 064100	Re:					Contrac	t For: Millwork		
Proposed Substitution: Substitute specified MDF core material in the specifications and casework detail pages for more economical IPB Manufacturer: Lakewood Cabinetry Address: 36775 S. Hwy 82 Langley, OK 74350 Phone: 918-782-2203 Phone: 918-782-2203  Attached data includes product description, specifications, drawings, photographs, and performance and test data adequate for evaluation of the request; applicable portions of the data are clearly identified.  Attached data also includes a description of changes to the Contract Documents that the proposed substitution will require for its proper installation.  The Undersigned certifies:  Proposed substitution has been fully investigated and determined to be equal or superior in all respects to specified product.  Same warranty will be furnished for proposed substitution as for specified product.  Same maintenance service and source of replacement parts, as applicable, is available.  Proposed substitution will have no adverse effect on other trades and will not affect or delay progress schedule.  Proposed substitution will have no adverse effect on other trades and will not affect or delay progress schedule.  Proposed substitution will have no adverse effect on other trades and will not affect or delay progress schedule.  Proposed substitution will have no adverse effect on other trades and will not affect or delay progress schedule.  Payment will be made for changes to building design, including A/E design, detailing, and construction costs caused by the substitution.  Submitted by:  Nathan Cassity  Nether Canada  ME's REVIEW AND ACTION  Substitution approved - Make submittals in accordance with Specification Section 01 25 00 Substitution Procedures.  Substitution rejected - Use specified materials.  Substitution Reguest received too late - Use specified materials.  Substitution Reguest received too late - Use specified materials.	Specifica	ation Ti	itle: Archi	tectural Wood C	Casework	Descri	iption: Panel core i	material	
Manufacturer: Lakewood Cabinetry Address: 36775 S. Hwy 82 Langley, OK 74350 Phone: 918 - 782 - 2203 Model No.:  Attached data includes product description, specifications, drawings, photographs, and performance and test data adequate for evaluation of the request; applicable portions of the data are clearly identified.  Attached data also includes a description of changes to the Contract Documents that the proposed substitution will require for its proper installation.  The Undersigned certifies:  Proposed substitution has been fully investigated and determined to be equal or superior in all respects to specified product.  Same warranty will be furnished for proposed substitution as for specified product.  Same maintenance service and source of replacement parts, as applicable, is available.  Proposed substitution will have no adverse effect on other trades and will not affect or delay progress schedule.  Proposed substitution will have no adverse effect on other trades and will not affect or delay progress schedule.  Prayment will be made for changes to building design, including A/E design, detailing, and construction costs caused by the substitution.  Submitted by:  Nathan Cassity  Nedex Canaly  Firm:  Lakewood Cabinetry, Inc.  36775 S. Hwy 82 Langley, OK 74350  Telephone:  918 - 782 - 2203  A/E's REVIEW AND ACTION  Substitution approved - Make submittals in accordance with Specification Section 01 25 00 Substitution Procedures.  Substitution rejected - Use specified materials.  Substitution rejected - Use specified materials.	Section:	064	4100	_ Page: _ 281		Article	e/Paragraph: 2.2 -	B - 1 (Plans	A6-01, A6-02)
Manufacturer: Lakewood Cabinetry Address: 36775 S. Hwy 82 Langley, OK 74350 Phone: 918 - 782 - 2203 Model No.:  Attached data includes product description, specifications, drawings, photographs, and performance and test data adequate for evaluation of the request; applicable portions of the data are clearly identified.  Attached data also includes a description of changes to the Contract Documents that the proposed substitution will require for its proper installation.  The Undersigned certifies:  Proposed substitution has been fully investigated and determined to be equal or superior in all respects to specified product.  Same warranty will be furnished for proposed substitution as for specified product.  Same maintenance service and source of replacement parts, as applicable, is available.  Proposed substitution will have no adverse effect on other trades and will not affect or delay progress schedule.  Proposed substitution will have no adverse effect on other trades and will not affect or delay progress schedule.  Prayment will be made for changes to building design, including A/E design, detailing, and construction costs caused by the substitution.  Submitted by:  Nathan Cassity  Nedex Canaly  Firm:  Lakewood Cabinetry, Inc.  36775 S. Hwy 82 Langley, OK 74350  Telephone:  918 - 782 - 2203  A/E's REVIEW AND ACTION  Substitution approved - Make submittals in accordance with Specification Section 01 25 00 Substitution Procedures.  Substitution rejected - Use specified materials.  Substitution rejected - Use specified materials.	Proposed	l Substi	itution: Sub	stitute specified MD	F core material in the spe	ecifications	s and casework detail	pages for more ec	onomical IPB
Attached data also includes a description of changes to the Contract Documents that the proposed substitution will require for its proper installation.  The Undersigned certifies:  Proposed substitution has been fully investigated and determined to be equal or superior in all respects to specified product.  Same warranty will be furnished for proposed substitution as for specified product.  Same maintenance service and source of replacement parts, as applicable, is available.  Proposed substitution will have no adverse effect on other trades and will not affect or delay progress schedule.  Prayment will be made for changes to building design, including A/E design, detailing, and construction costs caused by the substitution.  Submitted by:  Nathan Cassity  Nether Carolly  Lakewood Cabinetry, Inc.  36775 S. Hwy 82 Langley, OK 74350  Telephone:  918 - 782 - 2203  A/E's REVIEW AND ACTION  Substitution approved - Make submittals in accordance with Specification Section 01 25 00 Substitution Procedures.  Substitution approved as noted - Make submittals in accordance with Specification Section 01 25 00 Substitution Procedures.  Substitution Request received too late - Use specified materials.  Substitution Request received too late - Use specified materials.  Substitution Request received too late - Use specified materials.  Signed by:  Date: 8/7/25	Manufact	turer:					4350 Phone: 918 -	782 - 2203	
The Undersigned certifies:  Proposed substitution has been fully investigated and determined to be equal or superior in all respects to specified product.  Same warranty will be furnished for proposed substitution as for specified product.  Same maintenance service and source of replacement parts, as applicable, is available.  Proposed substitution will have no adverse effect on other trades and will not affect or delay progress schedule.  Proposed substitution does not affect dimensions and functional clearances.  Payment will be made for changes to building design, including A/E design, detailing, and construction costs caused by the substitution.  Submitted by:  Nathan Cassity  Nether Carnity  Firm:  Lakewood Cabinetry, Inc.  36775 S. Hwy 82 Langley, OK 74350  Telephone:  918 - 782 - 2203  A/E's REVIEW AND ACTION  Substitution approved - Make submittals in accordance with Specification Section 01 25 00 Substitution Procedures.  Substitution rejected - Use specified materials.  Substitution Request received too late - Use specified materials.  Substitution Request received too late - Use specified materials.  Signed by:  Date: 8/7/25	Attached of the req	l data in quest; a	ncludes pro pplicable p	duct description, sportions of the data a	ecifications, drawings, pare clearly identified.	hotograpl	hs, and performance a	and test data adeq	uate for evaluation
Proposed substitution has been fully investigated and determined to be equal or superior in all respects to specified product.  Same warranty will be furnished for proposed substitution as for specified product.  Proposed substitution will have no adverse effect on other trades and will not affect or delay progress schedule.  Proposed substitution does not affect dimensions and functional clearances.  Payment will be made for changes to building design, including A/E design, detailing, and construction costs caused by the substitution.  Submitted by:  Nathan Cassity  Signed by:  Lakewood Cabinetry, Inc.  36775 S. Hwy 82 Langley, OK 74350  Telephone:  918 - 782 - 2203  A/E's REVIEW AND ACTION  Substitution approved - Make submittals in accordance with Specification Section 01 25 00 Substitution Procedures.  Substitution approved as noted - Make submittals in accordance with Specification Section 01 25 00 Substitution Procedures.  Substitution rejected - Use specified materials.  Substitution Request received too late - Use specified materials.  Signed by:  Date: 8/7/25	Attached installation	data a	lso include:	s a description of c	hanges to the Contract I	Ocument	s that the proposed su	ubstitution will rec	quire for its proper
Signed by:    Mathae Casolty	<ul> <li>Payr subs</li> </ul>	ment w	vill be mad	le for changes to			design, detailing, and	1 construction co	sts caused by the
Firm: Lakewood Cabinetry, Inc.  Address: 36775 S. Hwy 82 Langley, OK 74350  Telephone: 918 - 782 - 2203  A/E's REVIEW AND ACTION  Substitution approved - Make submittals in accordance with Specification Section 01 25 00 Substitution Procedures. Substitution approved as noted - Make submittals in accordance with Specification Section 01 25 00 Substitution Procedures.  Substitution rejected - Use specified materials.  Substitution Request received too late - Use specified materials.  Signed by:  Date: 8/7/25			WW 02 020	assity			***************************************		
Address: 36775 S. Hwy 82 Langley, OK 74350  Telephone: 918 - 782 - 2203  A/E's REVIEW AND ACTION  Substitution approved - Make submittals in accordance with Specification Section 01 25 00 Substitution Procedures. Substitution approved as noted - Make submittals in accordance with Specification Section 01 25 00 Substitution Procedures. Substitution rejected - Use specified materials. Substitution Request received too late - Use specified materials.  Signed by:  Date: 8/7/25		y		Cabinetry Inc					
Telephone:  918 - 782 - 2203  A/E's REVIEW AND ACTION  Substitution approved - Make submittals in accordance with Specification Section 01 25 00 Substitution Procedures.  Substitution approved as noted - Make submittals in accordance with Specification Section 01 25 00 Substitution Procedures.  Substitution rejected - Use specified materials.  Substitution Request received too late - Use specified materials.  Signed by:  Date: 8/7/25		_			OK 74350		THE SHOP OF THE STATE OF		
A/E's REVIEW AND ACTION  Substitution approved - Make submittals in accordance with Specification Section 01 25 00 Substitution Procedures.  Substitution approved as noted - Make submittals in accordance with Specification Section 01 25 00 Substitution Procedures.  Substitution rejected - Use specified materials.  Substitution Request received too late - Use specified materials.  Date: 8/7/25	Address:	_	01100.1	my oz Langley					<del></del>
Substitution approved - Make submittals in accordance with Specification Section 01 25 00 Substitution Procedures.  Substitution approved as noted - Make submittals in accordance with Specification Section 01 25 00 Substitution Procedures.  Substitution rejected - Use specified materials.  Substitution Request received too late - Use specified materials.  Signed by:  Date: 8/7/25	Telephon	ne: <u></u>	918 - 782	- 2203					
□ Substitution approved as noted - Make submittals in accordance with Specification Section 01 25 00 Substitution Procedures.  Substitution rejected - Use specified materials.  Substitution Request received too late - Use specified materials.  Signed by:  Date: 8/7/25	A/E's RE	EVIEW	AND ACT	ION		Homesey of whicherton			
Je Mills	Substi	itution itution	approved as rejected - U	s noted - Make subr Ise specified materi	nittals in accordance with	cation Sec n Specific	ction 01 25 00 Substitution Section 01 25 00	ution Procedures. O Substitution Proc	cedures.
Supporting Data Attached: Drawings Product Data Samples Tests Reports	Signed by	y:	5	Mile		Name and the lands of the	Calculate State Colored State	Date: 8/7	/25
	Supportin	ng Data	Attached:	Drawings	Product Data	Sam	ples Tests	Reports	

© Copyright 2007, Construction Specifications Institute, 110 South Union Street, Suite 100, Alexandria, VA 22314

Page 1

Form Version: June 2004 CSI Form 1.5C



# SUBSTITUTION REQUEST

Test to the second res			(During the Bidding Phase)
Project:_	Stormwater Maintenance and Operations Building	Substitution Request Number	"
То:	City of Tulsa	From: Smith Lighting Sales, I  Date: July 17th, 2025	nc.
Re:	LED Interior & Exterior Lighting		
Specifica	tion Title: LED Interior & Exterior Lighting  Section: 265600 & 265619 Page:	Description: LED Interior & Exte	rior Lighting
Proposed	Substitution: Type(s): F		
Manufact	urer: ABOVE ALL		
Address: Trade Na	me: Électrical	Phone: Model No.: _Re	fer to attached product data link.
Attached evaluation	data includes product description, specifications, drawings, of the request; applicable portions of the data are clearly	photographs, and performance ar	nd test data adequate for
	data also includes a description of changes to the Contract		
<ul><li>Prop</li><li>Samo</li><li>Samo</li><li>Prop</li><li>Prop</li><li>Payn</li></ul>	ersigned certifies: osed substitution has been fully investigated and determine e warranty will be furnished for proposed substitution as fo e maintenance service and source of replacement parts, as a osed substitution will have no adverse effect on other trade osed substitution does not affect dimensions and functional ment will be made for changes to building design, including titution.	r specified product. applicable, is available. s and will not affect or delay prog	ress schedule.
Submitted Signed by Firm: Address:	Smith Lighting Sales, Inc. Sarah James Smith Lighting Sales, Inc. 1221 East 33rd Street Tulsa, OK 74105		
Telephone	e: 918.978.8564		
Substi	VIEW AND ACTION  Itution approved - Make submittals in accordance with Specification approved as noted - Make submittals in accordance vitution rejected - Use specified materials.  Itution Request received too late - Use specified materials.		Products to be submitted must meet or exceed performance criteria scheduled on the drawings.
V	) - (////.VO)		8/12/25



SUBSTITUTION REQUEST (During the Bidding/Negotiating Phase)

PROJECT: Stormwater Maint. SUBSTITUTION REQUEST NUMBER:  PROJECT: Longie Roten	
TO: BKL Inc. Eng. DATE: 8/1/25	
RE: Metal Brilding Supplier Contract For:	
SPECIFICATION TITLE: Metal Building Sys. DESCRIPTION: MB SUPPLIED  SECTION: 133419 PAGE: 6 ARTICLE/PARAGRAPH: 2.3	
PROPOSED SUBSTITUTION: Steel Tech Bldg. Sys.  MANUFACTURER: Steel Tech Bldg. Sys.  PHONE: 580-430-1350  TRADE NAME: Steel Tech Bldg. Sys.  MODEL NO.: WWW. Steel tech.  Attached data includes product description, specifications, drawings, photographs, and performance and test data adequate for evaluation of the request; applicable portions of the data are clearly identified.  Attached data also includes a description of changes to the Contract Documents that the proposed substitution will require for its proper installation.	-boi
The Undersigned certifies: Proposed substitution has been fully investigated and determined to be equal or superior in all respects to specified product. Same warranty will be furnished for proposed substitution as for specified product. Same maintenance service and source of replacement parts, as applicable, is available. Proposed substitution will have no adverse effect on other trades and will not affect or delay progress schedule. Proposed substitution does not affect dimensions and functional clearances. Payment will be made for changes to building design, including A/E design, detailing, and construction costs caused by the substitution.	
SUBMITTED BY: Lannie Roten SIGNED BY:  FIRM: Steel Tech Bldg. Sys.  ADDRESS: 511 5. Kyler St.  TELEPHONE: 580-430-1350	
A/E's REVIEW AND RECOMMENDATION:  Approve Substitution—Make submittals in accordance with Specification Section 01 33 00 Submittal Procedures.  Approve Substitution as noted—Make submittals in accordance with Specification Section 01 33 00 Submittal Procedures.  Products to be submitted must meet or exceed performance criteria scheduled  Substitution Request received too late—Use specified materials. on the drawings.	
SIGNED BY:  SUPPORTING DATA ATTACHED: Drawings Product Data Samples Tests Reports  Page of Coto our Nebsite CSI Form 1.5C (August 2020 version)	

© 2020 The Construction Specifications Institute (CSI)

unw. steeltech. build

# SUBSTITUTION REQUEST (During the Bidding/Negotiaging



Place(e)

3 10 16 12 4 1 1 1 1 1 1 1 1 1	UBSTITUTION EQUEST NUMBER:
a Prost , BIL.	ROM: Lonnie Roter
TO: BKL Inc. D	ATE: 8/1/25
Eng. & Arch.	/E PROJECT NUMBER: 5W23-01-01
RE: Panel Gauges 4 c	ONTRACT FOR:
Panel Profiles	etal Blog D for 11 11 D
SPECIFICATION TITLE: Are-Engineered Wh	ESTRIPTION: METAL ROOT & Wall Volus
SECTION: /33419 PAGE: 10-11 A	RTICLE/PARAGRAPH: 2.59-2.6
PROPOSED SUBSTITUTION: Metal Wall 24ga MANUFACTURER: MRCI	. PBC & Metal Root Batter-Lok 2450 PHONE: 588-430-1350
TRADE NAME: ROOF & Wall Panels	MODEL NO.:
Attached data includes product description, specifications, drav	A size way in the complete water down the contract of the cont
adequate for evaluation of the request; applicable portions of t Attached data also includes a description of changes to the Cor require for its proper installation.	the data are clearly identified.
The Undersigned certifies:  Proposed substitution has been fully investigated and determ specified product.  Same warranty will be furnished for proposed substitution as Same maintenance service and source of replacement parts, a Proposed substitution will have no adverse effect on other tra Proposed substitution does not affect dimensions and functio Payment will be made for changes to building design, includin the substitution.	for specified product. as applicable, is available. ades and will not affect or delay progress schedule. anal clearances.
SUBMITTED BY: Longie Rotan	
SIGNED BY: STEEL TECH B	Ids. Sys.
ADDRESS: 511 S. Kyler St	
TELEPHONE: 580-430-1350	
A/E's REVIEW AND RECOMMENDATION:	
Approve Substitution—Make submittals in accordance with	Specification Section 01 33 00 Submittal Procedures.
Approve Substitution as noted—Make submittals in accordance Procedures.	ance with Specification Section 01 33 00 Submittal
X  Reject Substitution—Use specified materials.	
Substitution Request received too late—Use specified mate	DATE: 8/8/25
SUPPORTING DATA ATTACHED:	ata [ Samples [ Tests [ Reports [ ]
Page Of	CSI Form 1.5C (August 2020 version)

# SUBSTITUTION REQUEST During the Bidding/Negotisting



Place(e)

PROJECT: Stormwater Maint	SUBSTITUTION REQUEST NUMBER:
9 Operations Bldg.	FROM: Lonnie Roten
TO: BKL Inc. Eng. 9	DATE: 8/1/25
Arch.	A/E PROJECT NUMBER: SW 23-01-01
RE: Panel Gauges a	CONTRACT FOR:
Aunal Profile	
SPECIFICATION TITLE: Metal Building S	GESCRIPTION: Roof Pavels a Wallvons
SECTION: 133419 PAGE: 10-11	ARTICLE/PARAGRAPH: 2.542.6
PROPOSED SUBSTITUTION: Central States	- Central Span 24 gr.
	MU. PHONE:
TRADE NAME: Central Span	MODEL NO.:
Attached data includes product description, specifications, of adequate for evaluation of the request; applicable portions Attached data also includes a description of changes to the require for its proper installation.	of the data are clearly identified.
The Undersigned certifies: Proposed substitution has been fully investigated and dete specified product. Same warranty will be furnished for proposed substitution among the maintenance service and source of replacement par Proposed substitution will have no adverse effect on other Proposed substitution does not affect dimensions and fun Payment will be made for changes to building design, incluthe substitution.	as for specified product. ts, as applicable, is available. trades and will not affect or delay progress schedule. ctional clearances.
SUBMITTED BY: Lounie Roten	DA _
SIGNED BY:	Ka 63
FIRM: Steel lech S	ldg Dys.
ADDRESS: 91 3. 1915 3 TELEPHONE: 580-430-7350	<u> </u>
TELEPHONE: 580-450-1350	
A/E's REVIEW AND RECOMMENDATION:	
Approve Substitution—Make submittals in accordance v	1
Approve Substitution as noted—Make submittals in acc Procedures.	ordance with Specification Section 01 33 00 Submittal
X Reject Substitution—Use specified materials.	
Substitution Request received too late—Use specified m	
SIGNED BY: Wiles	DATE: 8/8/25
SUPPORTING DATA ATTACHED: Drawings Produc	t Data Samples Tests Reports

ITEM	SPEC. NO.	DESCRIPTION	PAY ITEM	UNIT	QUANTIT
NUMBER		GENERAL REQUIREMENTS AND MOBILIZATION	NOTE	LSUM	1
1 2	DIV 1 012100	OWNERS ALLOWANCE		ALLOW	170,000
3	033000	CONCRETE SLAB AND SLAB EDGE	1	CY	411
4	032000/033000	ELEVATED CONCRETE SLAB, REINFORCED	1	CY	15
5	032000/033000	REINFORCED CONCRETE FOOTINGS	1	CY	41
6	033543	SCONC - SEALED CONCRETE	1	SF	1,358
7	033543	PCONC1 - POLISHED CONCRETE FINISHING	1	SF.	8,201
8	042200	M8 - 8" BURNISHED BLOCK - FULLY GROUTED	1	SF.	1,176
9	042200	M8 - 8" BURNISHED BLOCK		SF_	1,386
10	042200	NOT USED	$\sim\sim$	حض	$\sim$
11	042613	M4 - 4" BURNISHED BLOCK	~~~	SF	357
12	051213	STEEL CANOPY STRUCTURE	1, 6	LB	14,430
13	064100	WD - WOOD BASE	1	LF	328
14	064100	WD - CHAIRRAIL	1	LF	546
15	061000	PLYWOOD AT MECH ROOM	1	SF	361
16	064116	6.BSINK SINK BASE CABINET - 36x34x24	1	EA	3
17	064116	6.BWKSFADA-ADA WORKSURFACE BASE CABINET - 30x34x24	1	EA	1
18	064116	6.BWKSF - WORKSURFACE BASE CABINET - 36x34x24	1	EA	3
19	064116	6.BTRSH - TRASH BASE CABINET WITH 8" COUNTER RING- 18x34x24	1	EA	4
20	064116	6.B2DRW - 2 DRAWER BASE CABINET - 24x34x24	1	EA	3
21	064116	6.B3DRW - 3 DRAWER BASE CABINET - 18x34x24	1	EA	2
22	064116	6.B3DRW - 3 DRAWER BASE CABINET - 27x34x24	1	EA	1
23	064116	6,B3DRW - 3 DRAWER BASE CABINET - 28x34x24	1	EA	1
24	064116	6,B3DRW - 3 DRAWER BASE CABINET - 15x30x24	1	EA	2
25	064116	6.B3DRW - 3 DRAWER BASE CABINET - 30x24x24	1	EA	2
57.533		6.B3DRW - 3 DRAWER BASE CABINET - 30x42x24	1	EA	2
26 27	064116 064116	6.B1DRW2DR - 1 DRAWER + 1 DOOR BASE CABINET - 16x34x24	1	EA	1
28	064116	6.B2DRW2DR - 2 DRAWER + 2 DOOR BASE CABINET -	1	EA	1
29	064116	24x34x24 6,B2DRW2DR - 2 DRAWER + 2 DOOR BASE CABINET - 27x34x24	1	EA	2
30	064116	6.B2DRW2DR - 2 DRAWER + 2 DOOR BASE CABINET - 30x34x24	1	EA	6
31	064116	6.B2DRW2DR - 2 DRAWER + 2 DOOR BASE CABINET - 32x34x24	1	EA	6
32	064116	6.B2DRW2DR - 2 DRAWER + 2 DOOR BASE CABINET - 36x34x24	1	EA	5
33	064116	6.U2DR - 1 DOOR UPPER CABINETS - 16x30x15	1	EA	1
34	064116	6.U2DR - 1 DOOR UPPER CABINETS - 18x30x15	1	EA	2
35	064116	6.U2DR - 2 DOOR UPPER CABINETS - 24x30x15	1	EA	4
100.00	064116	6.U2DR - 2 DOOR UPPER CABINETS - 30x30x15	1	EA	2
36	064116	6.U2DR - 2 DOOR UPPER CABINETS - 32x30x15	<u>i</u>	EA	6
37	064116	6.U2DR - 2 DOOR UPPER CABINETS - 32x30x15	1	EA	2
38	064116	6.U2DR - 2 DOOR UPPER CABINETS - 35x30x15	<u>_</u>	EA	2
39	064116	6.U2DR - 2 DOOR UPPER CABINETS - 36x30x15	1	EA	2
40	064116	6.U2DR - 2 DOOR UPPER CABINETS - 36x24x15	<u> </u>	EA	5
41		6.UCSU - OPEN SHELF - 36x30x15	1	EA	2
42	064116 064116	6.UCSU - OPEN SHELF - 36X30X15 6.UCSU - OPEN SHELF CORNER UNIT - 30X30X15	1	EA	1
43	531115	6.BM - BENCH UNIT 60"	1	EA	2
44	064116 064116	6 BN - BENCH UNIT SIDE TABLE	1	EA	3
45	064116	6.RECDESK - RECEPTION DESK WITH TRANSACTION	1	LF	14
1970	552565-55-55-85	COUNTER  A RECDESK DECERTION DESK	1	LF	5
47	064116	6.RECDESK - RECEPTION DESK	1	EA	2
48	064116	6.VAN - RESTROOM VANITY 84x32x22		EA	2
49	064116	6.VAN - RESTROOM VANITY 36x32x22	1	EA	1
50	064116	6 VAN - RESTROOM VANITY 33x32x22		SF	840
51	072100	THERMAL INSULATION	1	SF	1,890
52	075423	TPO ROOFING SYSTEM	1	SYS	1,690
53	079200	JOINT SEALANTS	1	010	

ITEM NUMBER	SPEC. NO.	DESCRIPTION	PAY ITEM NOTE	UNIT	QUANTI
54	081113, 081416, 087100	TYPE A -36" WOOD DOOR, H.M. FRAME, AND HARDWARE	1, 3, 20	EA	32
55	081113, 087100	TYPE A -PAIR 36" H.M. DOORS, H.M. FRAME, AND	1, 3, 20	EA	4
56	081113, 081416,	HARDWARE  TYPE A -PAIR 36" WOOD DOORS, H.M. FRAME, AND	1, 3, 20	EA	6
57	087100 081113, 087100,	TYPE B - H.M. DOOR, H.M. FRAME, AND HARDWARE -	1, 3, 20	EA	9
58	088000 081113, 087100	FEMA DOOR, H.M. FRAME, AND HARDWARE	1, 3	EA	2
59	084113, 087100,	PAIR AL FRAME DOOR WITH GLASS, AL FRAME, AND	1, 3, 20	EA	3
60	088000 084113/088000	HARDWARE ALUM, STOREFRONT AND GLAZING	1, 2	SF	962
61	083613	OVERHEAD SECTIONAL DOOR	1, 3	EA.	1
62	092216/092900	P1 - PARTITION	1, 4	SF	1,327
63	092216/092900	P1A - PARTITION	1, 4	SF	6,573
373.0			1, 4	SF	4,520
64	092216/092900	P1AF - PARTITION			000,000
65	092216/092900	P1F - PARTITION	1, 4	SF	2.09
66	092216/092900	P2 - PARTITION	1, 4	SF	
67	092216/092900	P2A - PARTITION	1, 4	SF	305
68	092216/092900	P3FT - PARTITION	1, 4	SF	762
69	092216/092900	P4TT - PARTITION	1, 4	SF	265
70	092216/092900	P5A - PARTITION	1, 4	SF	249
71	092216/092900	P5AF - PARTITION	1, 4	SF	1,39
72	092216/092900	P6 - PARTITION	1, 4	SF	6,28
73	092216/092900	P6A - PARTITION	1, 4	SF	642
74	092216/092900	P6F - PARTITION	1, 4	SF	1,25
75	092216/092900	P6AF - PARTITION	1, 4	SF	42
76	092216/092900	P7T - PARTITION	1, 4	SF	34
77	092216/092900	P7AT - PARTITION	1, 4	SF	142
78	092216/092900	P7TAF - PARTITION	1, 4	SF	183
79	092216/092900	P11AF - PARTITION	1, 4	SF	432
80	092216/092900	P12AF - PARTITION	1, 4	SF	179
81	092216/092900	GYP BD CEILINGS	1, 4	SF	1,37
82	093013	9.CT1 - PORCELAIN TILE (RESTROOM AND ENTRY FLOOR)	1, 8	SF	1,91
83	093013	9.CT2 -PORCELAIN TILE (EXTERIOR TILE)	1, 8	SF	1,24
84	093013	9,CT3 - PORCELAIN TILE (FLOORS)	1, 8	SF	733
		9.CT3 - PORCELAIN TILE (BASE)	1, 8	SF	367
85	093013	9.CT3 - PORCELAIN TILE (BAGE)	1, 8	SF	1,62
86	093013 093013	9.CT4 - PORCELAIN TILE (ACCENT AT RESTROOM WALLS)  WALLS)	1, 8	SF	42
88	093013	9.CT5 - PORCELAIN TILE (BACKSPLASHES AND	1, 8	SF	215
89	095123	RECEPTION ACCENT)  9.ACT1.2 - ACOUSTICAL CEILING TILES AND GRID	1, 7	SF	4,25
	005402	9.ACT 2.2 - ACOUSTICAL CEILING TILES AND GRID (HIGH	1, 7	SF	5,65
90	095123	ACOUSTICS)  9.ACT3.2 - ACOUSTICAL CEILING TILES AND GRID (HIGH	~~~	m	<u></u>
90B	095124	HUMIDITY)	1, 7	SF	427
91	096513	9.RB1 - RUBBER BASE	1, 9	LF	2,98
92	096813	9.CPT1 - CARPET TILES - OFFICES	1, 10	SY	749
93	097200	VINYL WALL COVERING AT MUD ROOM	1	SF	185
94	098433	9.AWP1, 9.AWP3, AND 9.AWP4 - ACOUSTICAL WALL PANELS	1	SF	1,16
95	098433	9.AWP2 - ACOUSTICAL WALL PANELS WITH WOOD SLATS	1	SF	2,55
96	099133	PAINT - EXTERIOR STEEL CANOPY	1, 6	SYS	2
97	099123	PAINT - GYP WALLS	1, 6	SF	41,73
98	099123	PAINT - GYP CEILING	1, 6	SF	1,52
99	099123	PAINT - EXP CEILING	1, 6	SF	5,56
100	101100	10.MB9648 - MARKERBOARD 96" X 48"	1	EA	8
101	101100	MARKERBOARD MARKER KITS	1	EA	4
102	101416	PLAQUES	1	EA	1
103	101419	BUILDING SIGNAGE - DIMENSIONAL LETTERS	1	SYS	1
104	101419	DECORATIVE CONFERENCE ROOM SIGNAGE	1	SYS	1
105	101423	EVACUATION SIGNAGE	1	EA	15
106	101423	ROOM ID SIGNAGE	1	EA	13
107	101423	ROOM ID SIGNAGE WITH INSERT	1	EA	23
22/2012		CAN TOR MODULE WAS DESCRIBED A CHARLES OF THE PROPERTY.	1	EA	8

		PAY ITEM SCHEDULE - BASE BID CONT.			
ITEM NUMBER	SPEC. NO.	DESCRIPTION	PAY ITEM NOTE	UNIT	QUANTI
109	101423	RESTROOM SIGNAGE	1	EA	5
110	101423	REFUGE SIGNAGE	1	EA	2
111	101423	VINYL ON GLASS	1	EA	1
112	102113	10.TP - TOILET PARTITION (STANDARD)	1	EA	5
113	102113	10.TP - TOILET PARTITION (URINAL SCREEN)	1	EA	1
114	102113	10.TP - TOILET PARTITION (ADA)	1	EA	4
115	102239	10.FP - FOLDING PARTITION WALL	1	SF	420
116	102600	10.WP - WALL AND DOOR PROTECTION	1	EA	35
117	102800	10.MU - MIRROR 72" WIDE X 48" TALL	1	EA	2
118	102800	10.MU - MIRROR 36" WIDE X 48" TALL	1	EA	2
119	102800	10.MU - MIRROR 33" WIDE X 48" TALL	1	EA	1
120	102800	10.DTPW - DUAL TOILET PAPER ROLL WITH SHELF	1	EA	10
121	102800	10.TSC - TOILET SEAT COVER	1	EA	10
122	102800	10.SND - SANITARY NAPKIN WASTE	1	EA	6
123	102800	10.GB42 - 42" GRAB BAR	1	EA	5
124	102800	10.GB36 - 36" GRAB BAR	1	EA	5
125	102800	10.GB18 - 18" GRAB BAR	1	EA	6
126	102800	10.GBSHR - SHOWER GRAB BAR	1	EA	1
127	102800	10.SDW - SOAP DISPENSER	1	EA	10
128	102800	10.PTDW - PAPER TOWEL DISPENSER	1	EA	5
129	102800	10.CPTD12 - RECESSED COMBO PAPER TOWEL DISPENSER AND 12 GALLON WASTE CAN	1	EA	5
130	102800	10.MHS - MOP AND BROOM HOLDER WITH SHELF	1	EA	2
131	102800	10.SRHC - 3' SHOWER ROD, HOOKS AND 4' (MIN) WIDE CURTAIN	1	EA	1
132	102800	10.RH - ROBE HOOK	1	EA	3
133	102800	10.CSS - CORNER SHOWER SHELF	1	EA	1
134	102800	10.WSS - WALL MOUNTED FOLDING SHOWER SEAT	1	EA	10
135	102800	10.CG - METAL CORNER GUARD	1	EA	47
136	105129	10.LK - PHENOLIC LOCKERS (15W X 18D X 72H)	1	EA	3
137	104413/104416	10.FEC - FIRE EXTINGUISHERS AND CABINETS	1	EA	6
138	104413/104416	10.AED - AUTOMATIC EMERGENCY DEFIBRILLATOR	1	EA	1
139	122413	WT3 - ROLLER WINDOW SHADES 48X48	1	EA	16
140	122413	WT4 - ROLLER WINDOW SHADES 48X86	1	EA	5
141	122413	WT5 - ROLLER WINDOW SHADES (3) 48X48 GROUPED TOGETHER	1	EA	2
142	122413	WT6 - ROLLER WINDOW SHADES 36X48	1	EA	1
143	123661	12.SDSF - SOLID SURFACE COUNTERTOP - 25" DEEP WITH 1.5 INCH EDGE	1	SF	245
144	123661	12.SDSF - SOLID SURFACE VANITY - 22" DEEP WITH 1.5 INCH EDGE	1	SF	44
145	123661	12.SDSF - SOLID SURFACE TRANSACTION - 12" DEEP WITH 1.5 INCH EDGE	1	SF	14
146	123661	12.SDSF - SOLID SURFACE BACK SPLASH - 4"	1	SF	14

AND OPERATIONS BUILDING
PROJECT NO. SW23-01-01
CITY OF TULSA, OKLAHOMA
WATER AND SEWER DEPARTMENT

BKL, INCORPORATED ENGINEERS & ARCHITECTS

GREEN ACORN MECHANICAL, ELECTRICAL, & PLUMBING

STORMWATER MAINTENANCE

				PLAN SCALE:	DRAWN BY:	BKL	4/25	APPROVED:
NO	REVISION	BY	DATE	N/A	DESIGNED BY:	BKL	4/25	
1	ADDENDUM 3	BKL	08/14/24	IN/A	SURVEY BY:	TLS	9/24	
_				PROFILE SCALE	PROJ. MGR.			
				HORIZONTAL:	LEAD ENGR.			20
				N/A	FIELD MGR.			
_				VERTICAL:	RECOMMENDED	):		tono
				N/A	DESIGN MANAG	ER 🔨	2/2	CITY ENGINEER
_				FILE:	DRAWIN	_	0.	DATE
				ATLAS PAGE NO:			7,000,000	
				SHEET NAME: PAY QUA	ANTITIES	& NC	TES	SHEET NO. <b>G0-03</b>

ITEM	SPEC. NO.	DESCRIPTION	PAY ITEM NOTE	UNIT	QUANTIT
NUMBER	133419	NEW PRE-ENGINEERED METAL BUILDING	1, 21	SF	19,678
148	211313, 211316	FIRE SUPPRESSION	1	SF	19,678
149	224200	WC-1 FLOOR MOUNTED FLUSH VALVE WATER CLOSET (ADA)	1, 14	EA	5
150	224200	WC-2 FLOOR MOUNTED FLUSH VALVE WATER CLOSET	1, 14	EA	5
151	224200	UR-1 URINAL	1, 14	EA	3
152	224200	LAV-1 - DROP IN LAVORATORY	1, 13	EA	7
153	224200	SK-1 DOUBLE BOWL DROP-IN SINK	1, 13	EA	1
154	224200	SK-4 SINGLE BOWL DROP-IN SINK (ADA)	1, 13	EA	2
155	224200	EW-1 -EYE WASH STATION	1, 13	EA	1
156	224200	MSB-1 MOP SERVICE BASIN	1, 13	EA	2
157	224200	SH-1 SHOWER	1, 13	EA	1
158	224200	EWC-1 ELECTRIC WATER COOLER (ADA) SINGLE	1, 13	EA	1
159	224200	EWC-2 ELECTRIC WATER COOLER (ADA)	1, 13	EA	1
160	224200	IMB-1 ICE MAKER BOX	1	EA	7
161	224200	FPHB-1 FREEZEPROOF WALL HYDRANT	11	EA	6
162	224200	FPHB-2 FREEZEPROOF WALL HYDRANT (DUAL TEMP)	11	EA	1
163	224200	FPRH-1 FREEZEPROOF ROOF HYDRANT	1	EA	1
164	223400	WH-1 WATER HEATER	1	EA	1
165	223400	WH-2 WATER HEATER	1	EA	1
166	221116	CIRC PUMP SYSTEM AND PIPING	1	EA	2
167	221116	DCV-1 DOUBLE CHECK VALVE BACKFLOW PREVENTER 3"	1	SYS	1
168	221116	DCV-2 DOUBLE CHECK VALVE BACKFLOW PREVENTER	1	SYS	1
169	221316	YCO-1 YARD CLEANOUT	1	EA	4
170	221316	WCO-1 WALL CLEANOUT	1	EA	2
171	224200	FLOOR DRAIN	1	EA	16
172	224200	FS-1 FLOOR SINK	1	EA	1
173	224200	FCO-1 FLOOR CLEAN OUT	1	EA	4
174	224200	TD-1 TRENCH DRAIN	1	EA	1
175	224200	OI-1 OIL INTERCEPTOR	1	EA	1
176	221316	SANITARY PIPING	1	SYS	1
177	221116	DOMESTIC PIPING	1	SYS	1
178	221414	ROOF DRAIN SYSTEM	1	SYS	1
179	230000	COMPLETE MECHANICAL SYSTEM	1, 15	SYS	1
180	265200	A 2X4 RECESSED, 4000L	19	EA	66
181	265200	AE 2X4 RECESSED, 4000L, INTERGRAL BATTERY	19	EA	19
182	265200	B 2X2 RECESSED, 3200L	19	EA	33
183	265200	BE 2X2 RECESSED, 3200L, INTEGRAL BATTERY	19	EA	5
184	265200	D4 4" LED DOWNLIGHT, 2000L	19	EA	14
185	265200	D4E 4" LED DOWNLIGHT, 2000L, INTEGRAL BATTERY	19 19	EA	35
186	265200	D6 6" LED DOWNLIGHT, 2500L	19	EA	23
187	265200	D6E 6" LED DOWNLIGHT, 2500L, INTEGRAL BATTERY	1, 11	EA EA	1
188	265200	EM 20W LED MULLION MOUNTED EMERGENCY FIXTURE F 8W LED SPOT LIGHT MOUNTED DIRECTLY TO	19	EA	2
189	265200	JUNCTION BOX.  L1 5.6W/FT RECESSED LINEAR FIXTURE (7' 2-1/4"			
190	265200	LENGTH) L2 5.6W/FT RECESSED LINEAR FIXTURE (15' 5-1/4"	18, 19	EA	2
191	265200	LENGTH)	18, 19	EA	2
192	265200	L3E 5.6W/FT RECESSED LINEAR FIXTURE (23' 3/8" LENGTH). PROVIDE (3) EM AS INDICATED ON PLANS.	18, 19	EA	2
193	265200	P6 6' LED UP/DOWN PENDANT FIXTURE	19	EA	1
194	265200	P8 8' LED UP/DOWN PENDANT FIXTURE	19	EA	1
195	265200	P20 20' LED PENDANT FIXTURE, 675 LM/FT DOWN, 530 LM/FT UP, 20' AIRCRAFT CABLE MOUNT, INTEGRAL BATTERIES	19	EA	4
196	265200	P24 24' LED PENDANT FIXTURE, 675 LM/FT DOWN, 530 LM/FT UP, 20' AIRCRAFT CABLE MOUNT, INTEGRAL BATTERIES	19	EA	4
197	265200	P40 40' LED PENDANT FIXTURE, 675 LM/FT DOWN, 530 LM/FT UP, 20' AIRCRAFT CABLE MOUNT, INTEGRAL BATTERIES PER PLANS	19	EA	10
197B	265200 / 098436	40'-0" CEILING BAFFLES - MATCH MATERIAL AND SIZE OF PENDANT LIGHT P40.	1	EA	8
198	265200	S4 4' SURFACE MOUNTED LINEAR FIXTURE, 795LM/FT	19	EA	5
199	265200	S4E 4' SURFACE MOUNTED LINEAR FIXTURE, 795LM/FT, EM	19	EA	5
200	265200	S8 8' SURFACE MOUNTED LINEAR FIXTURE, 795LM/FT	19	EA	2
201	265200	ST 4' LED STRIP LIGHT 4100L (6.5W/FT)	19	EA	10
	265200	STE 4' LED STRIP LIGHT 4100L, INTEGRAL BATTERY	19	EA	3

ITEM IUMBER	SPEC. NO.	DESCRIPTION	PAY ITEM NOTE	UNIT	QUANTITY
203	265200	T-18000 LUMEN LED POLE LIGHT (PROVIDE 20' POLE AND 3' POLE BASE)	12, 19	EA	15
204	265200	W WALL MOUNTED LED FIXTURE WITH WALL MOUNT BRACKET.	19	EA	14
205	265200	WE WALL MOUNTED LED FIXTURE WITH WALL MOUNT BRACKET	19	EA	2
206	265200	WL 22' WALL WASH LED FIXTURE, 795 LM/FT	19	EA	1
207	265200	WW 4" LED WALL WASH DOWNLIGHT, 1000L	19	EA	3
208	265200	XC1 LED RED EXIT SIGN, SINGLE FACE, CEILING MOUNT	19	EA	5
209	265200	XC2 LED RED EXIT SIGN, DOUBLE FACE, CEILING MOUNT	19	EA	4
210	265200	XW1 LED RED EXIT SIGN, SINGLE FACE, WALL MOUNT	19	EA	8
211	260000	POWER SYSTEM	16, 19, 20	SYS	1
212	283111	FIRE ALARM SYSTEM	19	SF	19,678
213	202(A)	UNCLASSIFIED EXCAVATION	E-2, E-3, E-4, R-1	CY	2,205
214	202(D)	UNCLASSIFIED BORROW	E-3, E-4, R-1	CY	1,315
215	205(A)	TYPE A-SALVAGED TOPSOIL	-	CY	274
216	220	SWPPP DOCUMENTATION	E-6, E-7	LSUM	1
217	230(A)	SOLID SLAB SODDING	E-10, E-11	SY	2,445
218	231(A)	TREES	G-7	EA	2
219	240(A)	REMOVING TREES 6" TO 12" IN DIAMETER	G-7	EA	2
220	303(A)	AGGREGATE BASE TYPE A	S-2, 105	CY	1,257
221	310(B)	SUBGRADE, METHOD B	-	SY	4,092
222	325	SEPARATOR FABRIC	S-3	SY	4,223
223	414(B)	DOWEL JOINTED P.C.C. PAVT. (PLACEMENT)	S-10, S-11, S-13	SY	3,595
224	414(G)	P.C. CONCRETE FOR PAVEMENT	S-10, S-11, S-12, S-13	CY	601
225	601(A)	TYPE I PLAIN RIPRAP	-	TON	6
226	609	(PL) PARKING BLOCK	•	EA	54
227	609(A)	COMBINED CURB AND GUTTER (6" BARRIER)	S-10, S-12, S-13, S-15, S-16	LF	602
228	610(A)	4" CONCRETE SIDEWALK	S-12, S-13, S-16, S-17	SY	839
229	613(A)	24" REINFORCED CONCRETE PIPE (RCP), COMPLETE IN PLACE	D-8, D-12, D-13, D-16	LF	42
230	613(I)	8" NON-PERF.PIPE UNDERDRAIN RND.	D-13	LF	421
231	_613(L)_	24" PREFAB. CULVERT END SEC., ROUND	-0-60-	EA	2
232	613(Q)	OUTLET LATERAL HEADWALL	D-14	EA	2
233	619(B)	REMOVAL OF FENCE	R-1, R-2	LF	10
234	619(B)	REMOVAL OF ASPHALT PAVEMENT	R-1, R-2	SY	1,229
235	619(B)	REMOVAL OF EXISTING STRUCTURES	E-1, R-1, R-2, R-3, R-4, R-5	EA	1
236	619(B)	REMOVAL OF EXISTING PIPE	R-1, R-2, R-3, R-5	LF	49
237	624	(PL) WOOD PRIVACY FENCE W/ GATE	102	LF	39
238	850(A)	SHEET ALUMINUM SIGNS	T-2	SF	7
239	851(C)	1.5" SQUARE TUBE POST		LF	40
240	851(C)	2" SQUARE TUBE POST	**************************************	LF	10
241	856(A)	TRAFFIC STRIPE (PLASTIC)(4" WIDE)	T-3	LF	1,334
242	856(B)	TRAFFIC STRIPE (PLASTIC)(SYMBOLS)	T-3	EA	4
243	SPECIAL	12"X12" LANDSCAPING AREA INLET	104	EA	1
244	SPECIAL	DOWNSPOUT ADAPTER	101	EA	7
245	SPECIAL	CURB RAMP		EA	2
246	COT 309	6 INCH PVC AWWA C900 CLASS 200 DR-14 (RJ)	W-1, W-2, W-3, W-8, W-9, W-10, W-22, W-23, W-24, W-25, W-27, W-28, W-30, W-31	LF	140
247	COT 312	6 INCH DUCTILE IRON SLEEVE (RJ)	W-2, W-8, W-12	EA	3
248	COT 312	12 INCH DUCTILE IRON SLEEVE (RJ)	W-2, W-8, W-12	EA	2
249	COT 312	6 INCH X 3 INCH DUCTILE IRON TEE (RJ)	W-2, W-8	EA	1
250	COT 312	12 INCH X 6 INCH DUCTILE IRON TEE (RJ)	W-2, W-8	EA	1
251	COT 313	6" SANITARY SEWER LINE	103	LF	113
252	COT 315	3 INCH WATER SERVICE CONNECTION (LONG)	W-15, W-16, W-22, W-23, W-28, W-28, W-30, W-31	EA	1
253	COT 315	3 INCH COMPOUND WATER METER	W-25	EA	1
254	COT 315	3 INCH WATER METER VAULT	W-25	EA	1
	COT 317	6 INCH GATE VALVE (RJ)	W-8	EA	1
255	200 SAVE - 03458		200 00		
256	COT 318	VALVE BOX	W-21	EA	1

STORMWATER MAINTENANCE AND OPERATIONS BUILDING

PROJECT NO. SW23-01-01


CITY OF TULSA, OKLAHOMA WATER AND SEWER DEPARTMENT


S & ESTIMATES PREPARED BY:

BKL, INCORPORATED ENGINEERS & ARCHITECTS

GREEN ACORN MECHANICAL, ELECTRICAL, & PLUMBING

			PLAN SCALE:	DRAWN BY:	BKL	4/25	APPROVED:
REVISION	BY	DATE	NI/A	DESIGNED BY:	BKL	4/25	740-50-000 XXX-0-50-00
ADDENDUM 3	BKL	08/14/24	IN/A	SURVEY BY:	TLS	9/24	1
			PROFILE SCALE	PROJ. MGR.			1
			HORIZONTAL ·	LEAD ENGR.			1
		×	N/A	FIELD MGR.			1 1
			VERTICAL: N/A	RECOMMENDED	:		tan
				DESIGN MANAG	ER 🦪	DIL	CITY ENGINEER
			FILE:	DRAWIN	IG:		DATE:
			ATLAS PAGE NO:				
			SHEET NAME: PAY QUA	ANTITIES	TES	SHEET NO. <b>G0-04</b>	
	REVISION ADDENDUM 3			REVISION BY DATE N/A ADDENDUM 3 BKL 08/1424 PROFILE SCALE HORIZONTAL: N/A VERTICAL: N/A FILE: ATLAS PAGE NO: SHEET MAME:	REVISION BY DATE ADDENDUM 3 BKL 08/1424  PROFILE SCALE PROJ. MGR. HORIZONTAL: N/A VERTICAL: N/A PESIGN MANAG FILE: DRAWN ATLAS PAGE NO: SHEET NAME:	REVISION BY DATE ADDENDUM 3 BIG. 08/1424  PROFILE SCALE PROJ.MGR. HORIZONTAL: N/A FIELD MGR. VERTICAL: N/A PROSIGN MANAGER FILE: DRAWING: ATLAS PAGE NO: SHEET MAME:	REVISION

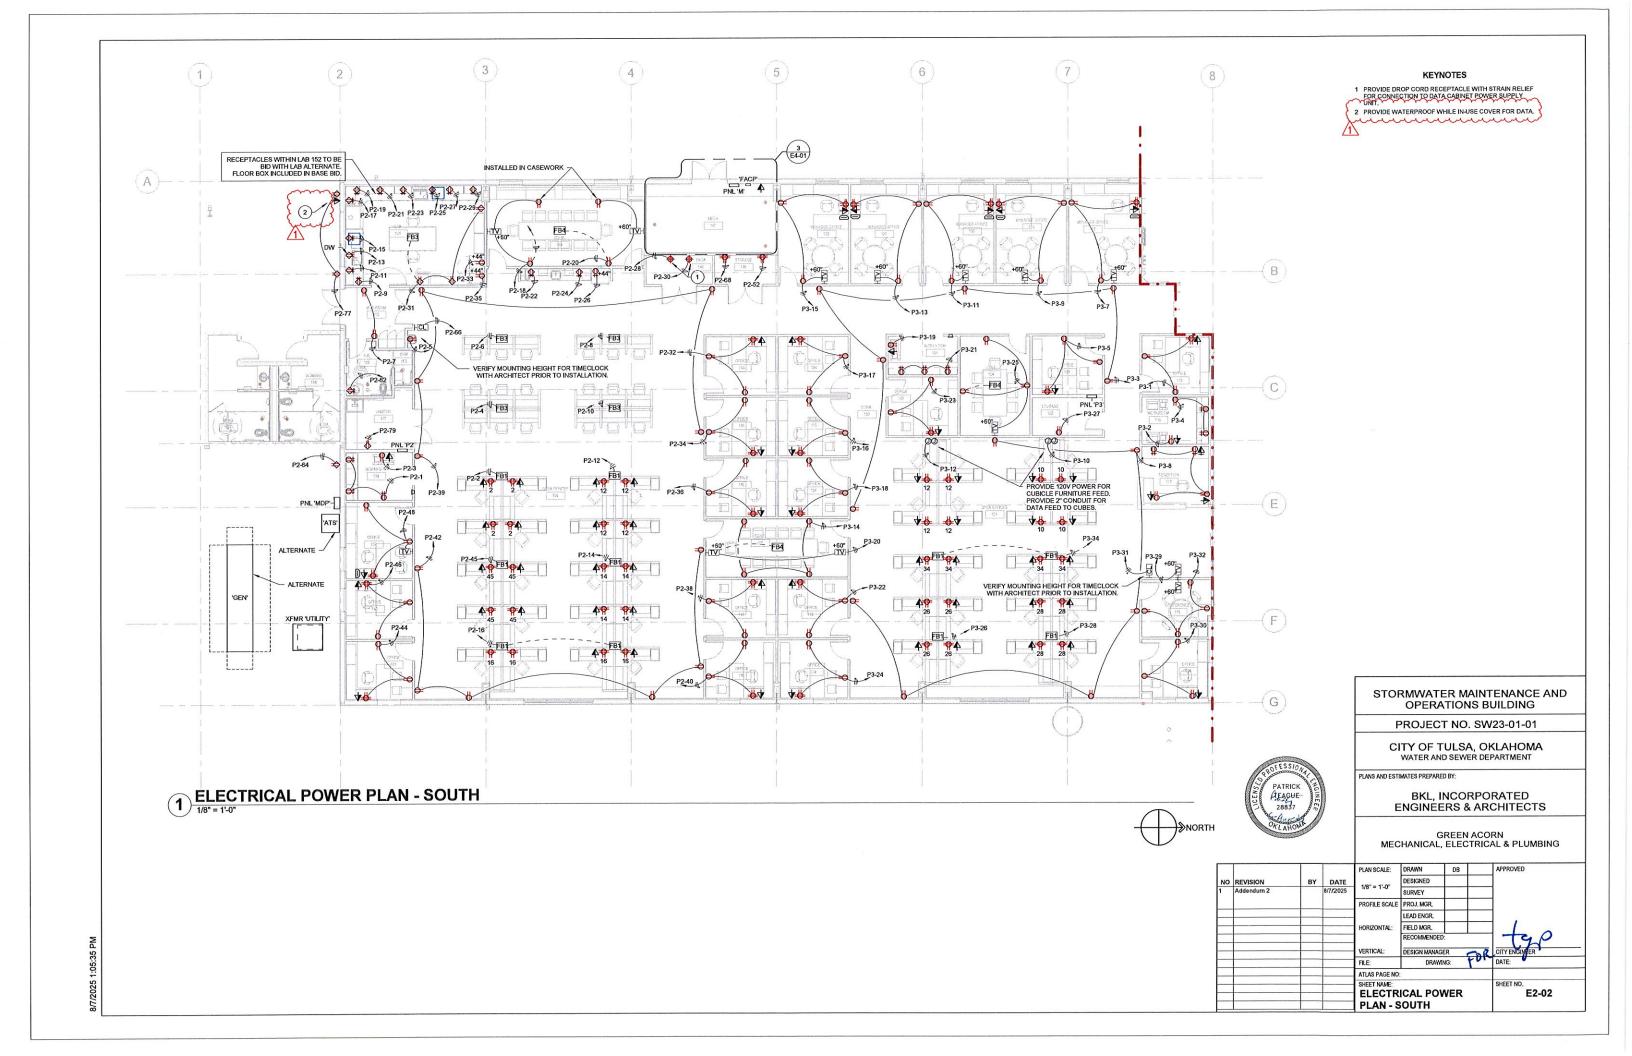

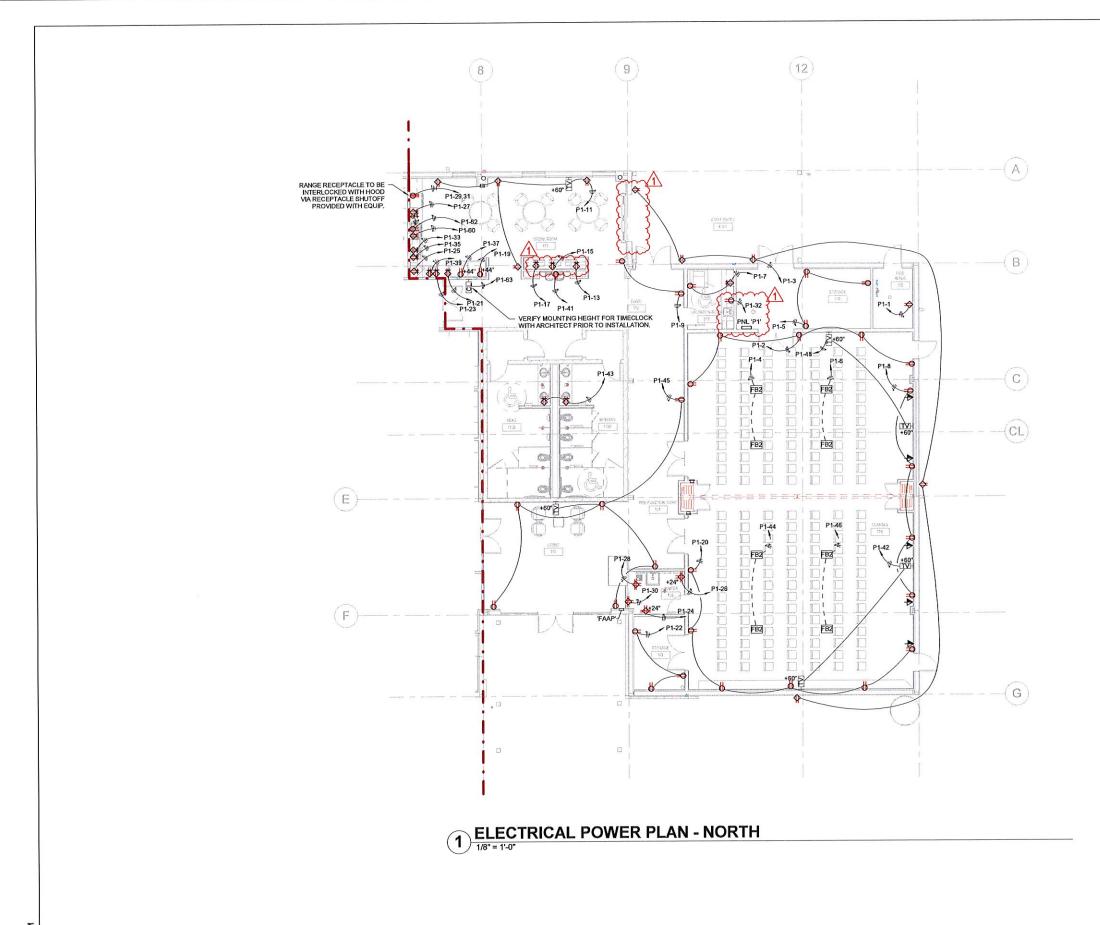

STORMWATER MAINTENANCE AND OPERATIONS BUILDING

PROJECT NO. SW23-01-01

CITY OF TULSA, OKLAHOMA WATER AND SEWER DEPARTMENT


PLANS AND ESTIMATES PREPARED E

BKL, INCORPORATED ENGINEERS & ARCHITECTS

GREEN ACORN MECHANICAL, ELECTRICAL & PLUMBING

			1	PLAN SCALE:	DRAWN	DR	AFFROVED
NO	REVISION	BY	DATE	1/8" = 1'-0"	DESIGNED		
1	Addendum 2		8/7/2025	1/8 = 1-0	SURVEY		
				PROFILE SCALE	PROJ. MGR.		
				1	LEAD ENGR.		
				HORIZONTAL:	FIELD MGR.		
					RECOMMENDED		7500
		_	-	VERTICAL:	DESIGN MANAGE	R C	CITY ENGINEER
				FILE:	DRAWII	NG:	DATE:
				ATLAS PAGE NO:			
				SHEET NAME: ELECTR NORTH	ICAL POV	VER -	SHEET NO. <b>E2-03</b>

7/2025 1:05:43 PN

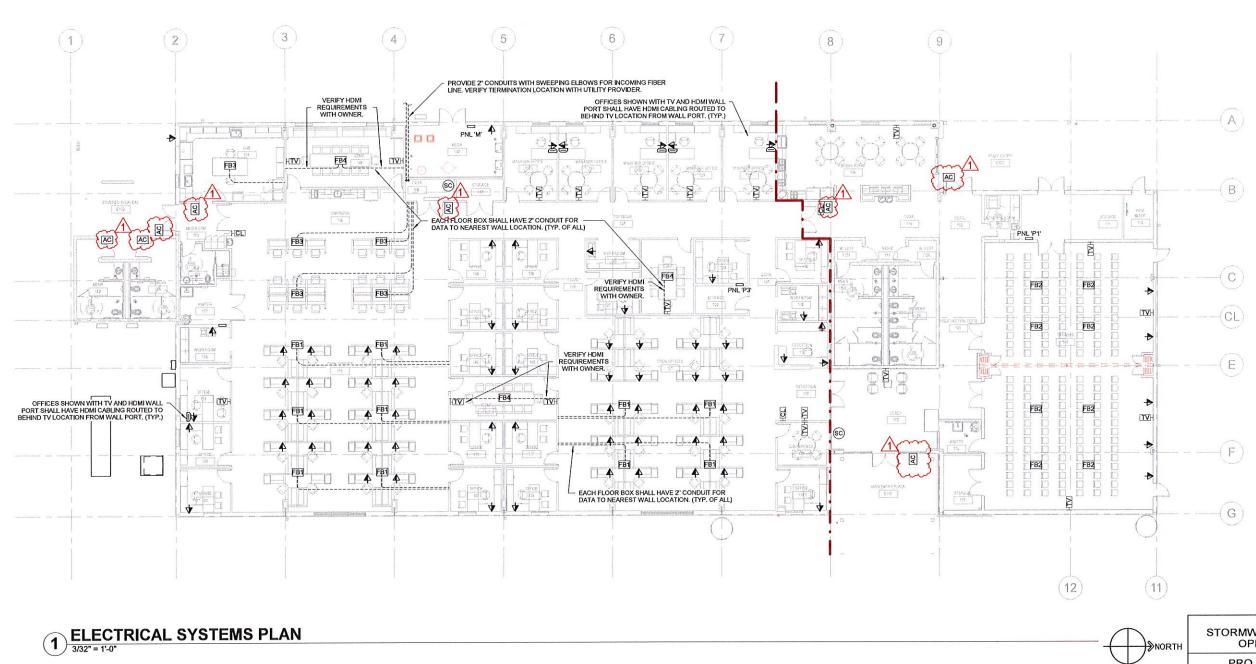

FLOOR BOX SCHEDULE

TYPE GANG 1 GANG 2 GANG 3 GANG 4 FINISH DESCRIPTION

FB1 FURN, FEED DATA NA NA BLACK LEGRAND EVOLUTION SERIES FURNITURE FEED, 1 POWER GANG, 1 DATA GANG (VERIEY QTY OF DATA WITH OWNER PRIOR TO INSTALLATION)

FB2 DUPLEX DUPLEX BLANK BLANK BLACK LEGRAND EVOLUTION SERIES 4-GANG FLOOR BOX.

FB3 DUPLEX DUPLEX ODUPLEX OF DATA BLANK BLACK LEGRAND EVOLUTION SERIES 4-GANG FLOOR BOX.

FB4 DUPLEX DUPLEX (4' DATA HDMI BLACK LEGRAND EVOLUTION SERIES 4-GANG FLOOR BOX.

STORMWATER MAINTENANCE AND OPERATIONS BUILDING

PROJECT NO. SW23-01-01


CITY OF TULSA, OKLAHOMA WATER AND SEWER DEPARTMENT


PLANS AND ESTIMATES PREPARED BY:


BKL, INCORPORATED ENGINEERS & ARCHITECTS

GREEN ACORN MECHANICAL, ELECTRICAL & PLUMBING


				PLAN SCALE:	DRAWN	DB		APPROVED
NO	REVISION	BY	DATE	3/32" = 1'-0"	DESIGNED			
1	Addendum 2		8/7/2025	3/32 = 1-0	SURVEY			
				PROFILE SCALE	PROJ. MGR.			
					LEAD ENGR.			
			-	HORIZONTAL:	FIELD MGR.			1
					RECOMMENDED	):		Test
_					DESIGN MANAG	ER	-0	CITY ENGINEER
				FILE:	DRAWI	NG:		DATE:
		_		ATLAS PAGE NO:				
				SHEET NAME: ELECTR PLAN	ICAL SYS	STEM		SHEET NO. <b>E2-11</b>

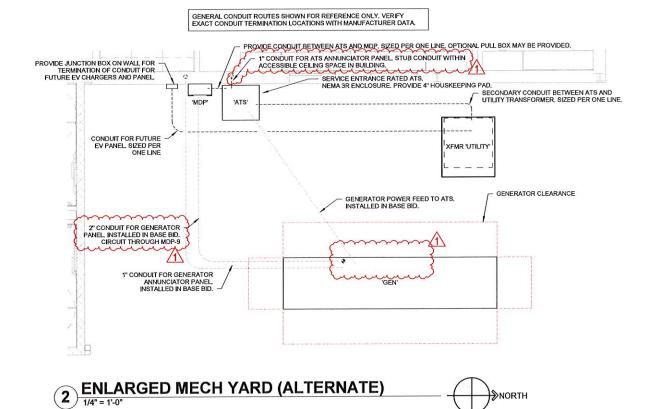

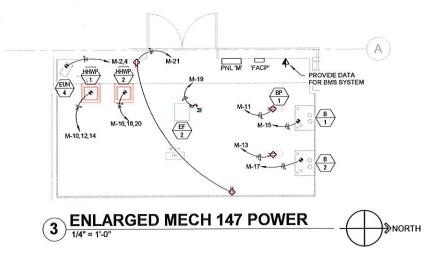

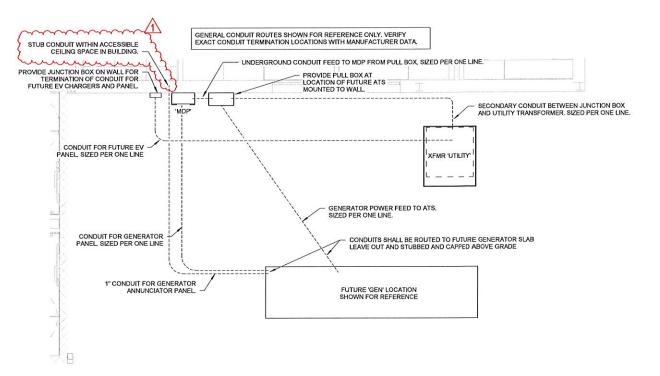

ENLARGED MECH YARD (BASE BID)

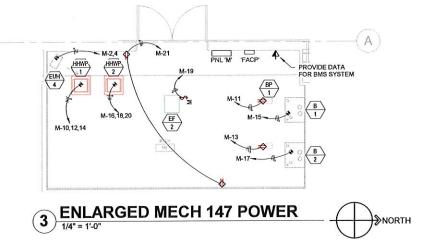



PROJECT NO. SW23-01-01


CITY OF TULSA, OKLAHOMA WATER AND SEWER DEPARTMENT

PLANS AND ESTIMATES PREPARED BY:


BKL, INCORPORATED ENGINEERS & ARCHITECTS

GREEN ACORN MECHANICAL, ELECTRICAL & PLUMBING


				PLAN SCALE:	DRAWN	DB		APPROVED
NO	REVISION	BY	DATE	1/4" = 1'-0"	DESIGNED			]
1	Addendum 2		8/7/2025	1 1/4" = 1:-0"	SURVEY			1
				PROFILE SCALE	PROJ, MGR.			1
					LEAD ENGR.			1988 1
-			-	HORIZONTAL:	FIELD MGR.			11.0
					RECOMMENDED	:		1 7360
		_		VERTICAL:	DESIGN MANAG	ER		CITY ENGINEER
				FILE:	DRAWI	NG:	TOK	DATE:
			_	ATLAS PAGE NO				
				SHEET NAME: ENLARG PLANS	ED ELEC	TRIC	AL	SHEET NO. <b>E4-01</b>

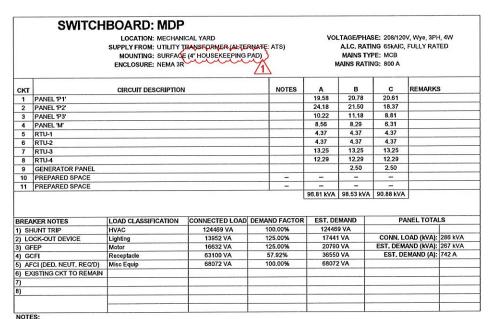

NOTES: PROVIDE 4" HOUSEKEEPING PAD UNDER 'MDP' MCB NOT INSTALLED IF GENERATOR ALTERNATE IS ACCEPTED.

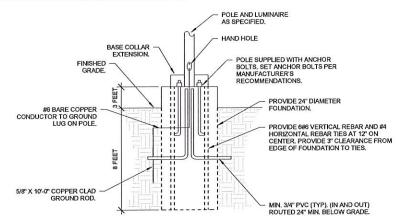


### POLE BASE DETAIL

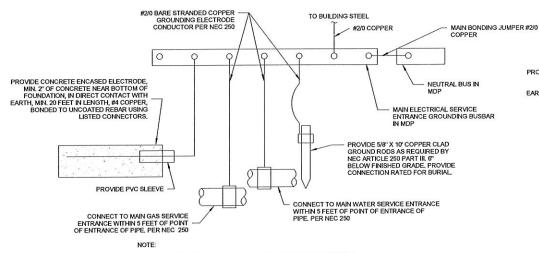

- PROVIDE GROUNDING OF TELECOMMUNICATIONS EQUIPMENT TO TELECOMMUNICATION MAIN GROUND BUSBAR PER TELECOMMUNICATION VENDOR'S DIRECTION. PROVIDE FOR BONDING OF WATER PIPE SYSTEM AT ALL WATER HEATER LOCATIONS. JUMPERS SHALL BE INSTALLED BETWEEN COLD AND HOT WATER PIPES AT WATER HEATER LOCATIONS. JUMPER SIZE SHALL BE #2/0 COPPER.

GROUNDING DETAIL (BASE BID) 2 GR N.T.S.

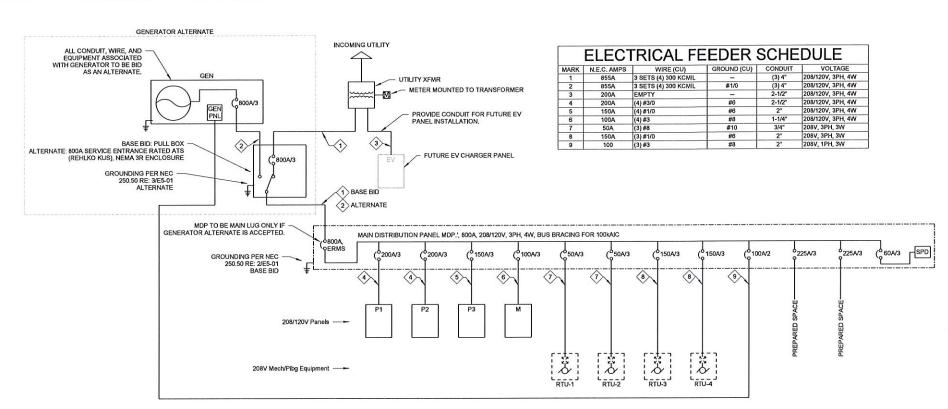

## 1 ELECTRICAL ONE LINE DIAGRAM

					DIESEL G	ENERATOR SCI	HEDULE				
TAG	MANUFACTURER	MODEL	VOLTS/PHASE		MAX db(A) @ FULL LOAD	HEATER RATING	BATTERY CHARGER (A)	WET WEIGHT (WITH FULL TANK)	DIMENSIONS (L"xW"xH")	TANK CAPACITY (GAL)	RUNTIME @ FULL LOAD
GEN	REHLKO	300REOZJ	208V/3ph	300	75	2500W (208V/1PH)	10A	17836 lbs.	220" x 25.7" x 124.9"	1074	48HR

TEAGUE 28837

RKS:
GENERATOR SHALL INCLUDE 4UA13 ALTERNATOR.
ENCLOSURE FINISH - BEIGE
PROVIDE INTEGRAL 208/120V, 1PH, 3W LOAD CENTER FOR POWERING OF LIGHTS, SERVICE RECEPTACLE, BATTERY CHARGER, AND HEATER.
MUFFLERS SHALL BE LOCATED WITHIN ENCLOSURE.
REMOTE ANNUNCIATOR - HARDWIRED
PROVIDE BEMERGENCY STOP BUTTON ON EXTERIOR OF GENERATOR ENCLOSURE.
PROVIDE CATWALKS FOR GENERATOR ENCLOSURE ACCESS.

#2/0 BARE STRANDED COPPER TO BUILDING STEEL GROUNDING ELECTRODE CONDUCTOR PER NEC 250 #2/0 COPPER MAIN BONDING JUMPER #2/0 0-PROVIDE CONCRETE ENCASED ELECTRODE MIN. 2" OF CONCRETE NEAR BOTTOM OF FOUNDATION, IN DIRECT CONTACT WITH NEUTRAL BUS IN EARTH, MIN. 20 FEET IN LENGTH, #4 COPPER, BONDED TO UNCOATED REBAR USING LISTED CONNECTORS. MAIN ELECTRICAL SERVICE ENTRANCE GROUNDING BUSBAR IN ATS PROVIDE \$/8" X 10' COPPER CLAD GROUND RODS AS REQUIRED BY NEC ARTICLE 250 PART III. 6" BELOW FINISHED GRADE. PROVIDE CONNECTION RATED FOR BURIAL. PROVIDE PVC SLEEVE CONNECT TO MAIN WATER SERVICE ENTRANCE WITHIN 5 FEET OF POINT OF ENTRANCE OF PIPE. PER NEC 250 CONNECT TO MAIN GAS SERVICE ENTRANCE WITHIN 5 FEET OF POINT OF ENTRANCE OF PIPE. PER NEC 250

PROVIDE GROUNDING OF TELECOMMUNICATIONS EQUIPMENT TO TELECOMMUNICATION MAIN GROUND BUSBAR PER TELECOMMUNICATION VENDOR'S DIRECTION. PROVIDE FOR BONDING OF WATER PIPE SYSTEM AT ALL WATER HEATER LOCATIONS. JUMPERS SHALL BE INSTALLED BETWEEN COLD AND HOT WATER PIPES AT WATER HEATER LOCATIONS. JUMPER SEA THE WATER HEATER LOCATIONS. JUMPER SIZE SHALL BE #2/0 COPPER.

**3** GROUNDING DETAIL (ALTERNATE)

STORMWATER MAINTENANCE AND **OPERATIONS BUILDING** 

PROJECT NO. SW23-01-01

CITY OF TULSA, OKLAHOMA WATER AND SEWER DEPARTMENT

**BKL, INCORPORATED ENGINEERS & ARCHITECTS** 

**GREEN ACORN** MECHANICAL, ELECTRICAL & PLUMBING

LAN SCALE: DRAWN DB APPROVED DESIGNED DATE SURVEY PROFILE SCALE PROJ. MGR. LEAD ENGR. FIELD MGR. ECOMMENDE 601 DRAWING: ATLAS PAGE NO: **ELECTRICAL DETAILS** E5-01

#### **PANELBOARD: P1**

LOCATION: STORAGE 106 SUPPLY FROM: MDP MOUNTING: SURFACE ENCLOSURE: NEMA 1

#### VOLTAGE/PHASE: 208/120V, Wye, 3PH, 4W A.I.C. RATING: 10kAIC, FULLY RATED MAINS TYPE: MLO MAINS RATING: 200 A

скт	CIRCUIT DESCRIPTION	WIRE SIZE (H,N,G) OR (H,G)	NOTES	TRIP	#	A	(VA)	80	(VA)	CI	(VA)	#	TRIP	NOTES	WIRE SIZE (H,N,G) OR (H,G)	CIRCUIT DESCRIPTION	скт
1	STORAGE 104	1-#12, 1-#12, 1-#12	HOTES	20 A	1	0.18		(	1	- (,	1	1	20 A	110120		TRAINING 103 WEST	2
	ENTRY PLAZA	1-#12, 1-#12, 1-#12		20 A	1	0,10	7	0.90	0.72			1	20 A			TRAINING 103 FB WEST	4
_	MECH/ELECT 106	1-#12, 1-#12, 1-#12		20 A	1			-1		0.54	0.72	1	20 A			TRAINING 103 FB WEST	6
_	LACTATION ROOM 107	1-#12, 1-#12, 1-#12		20 A	1	0.36	0.72					1	20 A			TRAINING 103 NORTH	8
9	CORRIDOR 109	1-#12, 1-#12, 1-#12		20 A	1	0,00		0.36	1,50								10
11	BREAK ROOM 108	1-#12, 1-#12, 1-#12		20 A	1					0.90	1,50	2	20 A		2-#12, 1-#12	EUH-1	12
	MICROWAVE	1-#12, 1-#12, 1-#12		20 A	1	1.10	1.50					-					14
-	MICROWAVE	1-#12, 1-#12, 1-#12		20 A	1			1.10	1.50			2	20 A		2-#12, 1-#12	EUH-2	16
-	MICROWAVE	1-#12, 1-#12, 1-#12		20 A	1					1.10	0.10	1	20 A		1-#12, 1-#12, 1-#12	EF-3	18
	FRIDGE	1-#12, 1-#12, 1-#12	4	20 A	1	0.80	1.08					1	20 A		1-#12, 1-#12, 1-#12	TRAINING 103 EAST	20
21	COUNTER	1-#12, 1-#12, 1-#12		20 A	1			0.18	0.54			1	20 A		1-#12, 1-#12, 1-#12	STORAGE 102	22
23	COFFEE MAKER	1-#12, 1-#12, 1-#12		20 A	1					1.60	0,36	1	20 A		1-#12, 1-#12, 1-#12	JAN 101	24
25	ICEMAKER	1-#12, 1-#12, 1-#12	1	20 A	1	0.60	0.36					1	20 A		1-#12, 1-#12, 1-#12	JAN 101	26
27	COUNTER	1-#12, 1-#12, 1-#12	<del></del>	20 A	1			0.18	0.36			1	20 A		1-#12, 1-#12, 1-#12	TANK PUMP	28
29				3	_					4.16	0.36	1	20 A		1-#12, 1-#12, 1-#12	JAN 101	30
31	RANGE	2-#6, 1-#6, 1-#10	4	60 A	2	4.16	0.70					1	20 A	4	1-#12, 1-#12, 1-#12	107 FRIDGE	32
33	COFFEE MAKER	1-#12, 1-#12, 1-#12	un	20 A	1			1.60	1.50			1	20 A		2-#12, 1-#12	EUH-3	34
35	COFFEE MAKER	1-#12, 1-#12, 1-#12		20 A	1					1,60	1,50	12	20 A		2-#12, 1-#12	EUH-3	36
37	FRIDGE	1-#12, 1-#12, 1-#12	4	20 A	1	0.80	0.18					1	20 A		1-#12, 1-#12, 1-#12	CP-1	38
39	COFFEE MAKER	1-#12, 1-#12, 1-#12		20 A	1			1.60	1.80			1	20 A		1-#12, 1-#12, 1-#12	WH-1	40
41	WATER COOLER	1-#12, 1-#12, 1-#12	4	20 A	1					0.70	0.36	1	20 A		1-#12, 1-#12, 1-#12	EAST TRAINING TV	42
43	RESTROOMS	1-#12, 1-#12, 1-#12		20 A	1	0.36	0.72					1	20 A		1-#12, 1-#12, 1-#12	EAST TRAINING FB	44
45	PRE-FUNCTION/LOBBY	1-#12, 1-#12, 1-#12		20 A	1			1.26	0.72			1	20 A			EAST TRAINING FB	46
47	EF-1	1-#12, 1-#12, 1-#12		20 A	1					0.41	0.36	1	20 A		1-#12, 1-#12, 1-#12	WEST TRAINING TV	48
49	FPB 3-1	1-#12, 1-#12, 1-#12	2	20 A	1	0.86	0.60					1	20 A		1-#12, 1-#12, 1-#12	NORTH EXTERIOR LTG.	50
51	FPB 3-2	1-#12, 1-#12, 1-#12	2	20 A	1			0.86	0.30			1	20 A		1-#12, 1-#12, 1-#12	NORTH LIGHTING	52
53	FPB 3-3	1-#12, 1-#12, 1-#12	2	20 A	1					1,18	1.01	1	20 A		1-#12, 1-#12, 1-#12	NW LIGHTING	54
55	FPB 3-4	1-#12, 1-#12, 1-#12	2	20 A	1	1.18	1.38					1	20 A		1-#12, 1-#12, 1-#12	OPEN AREA LIGHTING	56
57	KITCHEN HOOD	1-#12, 1-#12, 1-#12		20 A	1			0.60	1.81			1	20 A		1-#10, 1-#10, 1-#10	TRAINING PEND. LTG.	58
59	DRY RISER AC	2-#12. 1-#12		20 A	2				_	0.89	1.44	1	20 A		1-#12, 1-#12, 1-#12	DISHWASHER	60
61	DRT RISER AC	2-#12, 1-#12		20 A	-	0.89	1,18					1	20 A	4	1-#12, 1-#12, 1-#12	GARBAGE DISP	62
63	TIMECLOCK	1-#12, 1-#12, 1-#12		20 A	1			0.18	0.00			1	20 A	-	-	SPARE	64
65	SPARE	_	-	20 A	1		ega a nez			0,00	0.00	1	20 A	-	_	SPARE	66
67	SPARE		-	20 A	1	0.00	0.00			-		1	20 A	-	-	SPARE	68
69	SPARE	-	-	20 A	1			0.00	0.00			1	20 A	-	-	SPARE	70
71	SPARE	-	-	20 A	1					0.00	0.00	1	20 A	-	-	SPARE	72
73	SPARE	_	-	20 A	1	0.00	0.00					1	20 A	-	_	SPARE	74
	SPARE	_	-	20 A	1			0.00	0.00		1	1	20 A	-		SPARE	76
77	SPARE	-	-	20 A	1					0.00	0.00	1	20 A	-	-	SPARE	78
			To	tal Lo	ad:	20.6	1 kVA	19.5	8 kVA	20.78	kVA	J					

) SHUNT TRIP ) LOCK-OUT DEVICE	HVAC	11869 VA	100.00%	11869 VA		
			100,0070	11009 VA		
	Lighting	5106 VA	125.00%	6382 VA	TOTAL CONN. LOAD (kVA):	60.98 kVA
) GFEP	Motor	408 VA	125.00%	510 VA	TOTAL EST. DEMAND (KVA):	60.38 kVA
) GFCI	Receptacle	13960 VA	85.82%	11980 VA	TOTAL EST. DEMAND (A):	168 A
	Misc Equip	29636 VA	100.00%	29636 VA		
) EXISTING CIRCUIT TO REMAIN						
) THROUGH RELAY PANEL						
) THROUGH LIGHTING INVERTER						

#### **PANELBOARD: P2**

LOCATION: JANITOR 157 SUPPLY FROM: MDP MOUNTING: FLUSH ENCLOSURE: NEMA 1 VOLTAGE/PHASE: 208/120V, Wye, 3PH, 4W A.I.C. RATING: 22kAIC, FULLY RATED MAINS TYPE: MLO MAINS RATING: 200 A

скт	CIRCUIT DESCRIPTION	WIRE SIZE (H,N,G) OR (H,G)	NOTES	TRIP	#	A(k	(AV)	ВО	(VA)	C (k	(AV	#	TRIP	NOTES	WIRE SIZE (H,N,G) OR (H,G)	CIRCUIT DESCRIPTION	скт
1	WORKROOM 158 RCPTS	1-#12, 1-#12, 1-#12	HOILO	20 A	1	0.54	-	- (,	1	- 1.		1	20 A	2		OPEN OFFICE 150 FLRBOX	2
	COPIER	1-#12, 1-#12, 1-#12		20 A	1			0,80	0,36			1	20 A		1-#12, 1-#12, 1-#12	OPEN OFFICE 150 FLRBOX	4
-	EWC	1-#12, 1-#12, 1-#12	4	20 A	1	-				0.70	0.36	1	20 A		1-#12, 1-#12, 1-#13	OPEN OFFICE 150 FLRBOX	6
7	MUDROOM RCPTS	1-#12, 1-#12, 1-#12		20 A	1	0.36	0,36					1	20 A		1-#12, 1-#12, 1-#13	OPEN OFFICE 150 FLRBOX	8
9	LAB RCPT	1-#12, 1-#12, 1-#12		20 A	1			0.30	0.36			1	20 A			OPEN OFFICE 150 FLRBOX	10
	LAB RCPT	1-#12, 1-#12, 1-#12		20 A	1					0.30	1.44	1	20 A	2	1-#12, 1-#12, 1-#13	OPEN OFFICE 150 FLRBOX	12
-	LAB RCPT - DW	1-#12, 1-#12, 1-#12		20 A	1	1.44	1.44					1	20 A	2	1-#12, 1-#12, 1-#12	OPEN OFFICE 150 FLRBOX	14
	LABE DEIONIZER	1-#12, 1-#12, 1-#12		20 A	1	-	-	0.30	1.44			1	20 A	2	1-#12, 1-#12, 1-#13	OPEN OFFICE 150 FLRBOX	16
_	LAB RCPT	1-#12, 1-#12, 1-#12		20 A	1					0.30	0.54	1	20 A		1-#12, 1-#12, 1-#12	CONF 149 S. TV & FLRBOX	18
-	LAB RCPT	1-#12, 1-#12, 1-#12		20 A	1	0,30	0.90					1	20 A		1-#12, 1-#12, 1-#13	CONF 149 N. TV & FLRBOX	20
	LAB RCPT	1-#12, 1-#12, 1-#12		20 A	1			0.30	1.60	-		1	20 A		1-#12, 1-#12, 1-#12	COFFEE MAKER	22
	LAB RCPT	1-#12, 1-#12, 1-#12		20 A	1					0.30	1,60	1	20 A		1-#12, 1-#12, 1-#13	S KITCHENETTE COUNTER	24
	LAB DEIONIZER	1-#12, 1-#12, 1-#12		20 A	1	0.30	0.80					1	20 A	4	1-#12, 1-#12, 1-#12	FRIDGE	26
-	LAB RCPT	1-#12, 1-#12, 1-#12		20 A	1			0.30	0.18			1	20 A		1-#12, 1-#12, 1-#12	DATA 146 CEILING RCPT	28
29	LAB RCPT	1-#12, 1-#12, 1-#12		20 A	1	_				0.30	0.18	1	20 A		1-#12, 1-#12, 1-#12	DATA 146 CEILING RCPT	30
-	LAB RCPT	1-#12, 1-#12, 1-#12		20 A	1	0,90	0.72					1	20 A			OFFICE 145 RCPTS	32
	FRIDGE	1-#12, 1-#12, 1-#12	4	20 A	1			0,80	0.72			1	20 A		1-#12, 1-#12, 1-#12	OFFICE 144 RCPTS	34
_	FRIDGE	1-#12, 1-#12, 1-#12	4	20 A	1					0.80	0.72	1	20 A			OFFICE 143 RCPTS	36
	S. OFFICE LIGHTING	1-#12, 1-#12, 1-#12		20 A	1	0.68	0.72					1	20 A			OFFICE 141 RCPTS	38
_		1-#12, 1-#12, 1-#12		20 A	1	-,		0.90	0.72			1	20 A			OFFICE 140 RCPTS	40
	W. OPEN OFFICE LIGHTING			20 A	1					0.82	1.08	1	20 A		1-#12, 1-#12, 1-#12	E. OPEN OFFICE 150 RCPTS	42
	OPEN OFFICE LIGHTING	1-#12, 1-#12, 1-#12		20 A	1	0.82	0.72					1	20 A			OFFICE 161 RCPTS	44
		1-#12, 1-#12, 1-#12	2	20 A	1			1.44	0.72			1	20 A			OFFICE 160 RCPTS	46
47	E. OPEN OFFICE LIGHTING	1-#12, 1-#12, 1-#12		20 A	1					0.82	0.90	1	20 A			OFFICE 159 RCPTS	48
49	Manager Land					1.98	1.20					1	20 A	2	1-#12, 1-#12, 1-#12		50
51	DSO/DSI-2	2-#10, 1-#10		30 A	2			1.98	0.36	5		1	20 A	7 - 17 - 17	1-#12, 1-#12, 1-#12	IT EQUIP	52
53										1.98	1.50	-				51014	54
55	DSO/DSI-1	2-#10, 1-#10		30 A	2	1.98	1.50					2	20 A		2-#12, 1-#12	EWH-1	56
_	н	1-#12, 1-#12, 1-#12		20 A	1			1,80	0,45			1	20 A		1-#12, 1-#12, 1-#12	EXTERIOR RR LIGHTING	58
59	CP-2	1-#12, 1-#12, 1-#12		20 A	1					0.18	0.49	1	20 A		1-#12, 1-#12, 1-#12	SOUTH EXTERIOR LTG	60
61						1,50	0,18					1	20 A		1-#12, 1-#12, 1-#12	R.R. 156	62
63	EUH-5	2-#12, 1-#12		20 A	2			1.50	0.18			1	20 A		1-#12, 1-#12, 1-#12	MECH YARD RCPT	64
65	SOUTH EXHAUST	1-#12, 1-#12, 1-#12		20 A	1					0.52	0.18	1	20 A		1-#12, 1-#12, 1-#12	TIMECLOCK	66
67	FPB 4-2	1-#12, 1-#12, 1-#12	2	20 A	1	0.86	0.36					1	20 A		1-#12, 1-#12, 1-#12	IT EQUIP	68
69	1800 TO 1800 T							2.00									70
71	ECH-1	2-#10, 1-#10		30 A	2					2.00		Т		1			72
73						2.00				2							74
75	ECH-2	2-#10, 1-#10		30 A	2			2.00	0.00			1	20 A	-	-	SPARE	76
77	SW EXTERIOR RCTPS	1-#12, 1-#12, 1-#12		20 A	1					0.36	0.00	1	20 A	-	_	SPARE	78
79	JANITOR 157 RCPT	1-#12, 1-#12, 1-#12		20 A	1	0.18	0.00					1	20 A	-	-	SPARE	80
81					T				0.00			1	20 A	-	-	SPARE	82
	SPARE	_	-	20 A	1					0.00	0.00	1	20 A	-	-	SPARE	84
			To	tal Loa	d:	24.18	kVA	21.50	kVA	18.37	kVA						

BREAKER NOTES	LOAD CLASSIFICATION	CONNECTED LOAD	DEMAND FACTOR	ESTIMATED DEMAND	PANEL TOTALS	
1) SHUNT TRIP	HVAC	8768 VA	100,00%	8768 VA		
2) LOCK-OUT DEVICE	Lighting	4094 VA	125,00%	5117 VA	TOTAL CONN. LOAD (kVA):	64.06 kVA
B) GFEP	Motor	173 VA	125.00%	217 VA	TOTAL EST. DEMAND (KVA):	59.15 kVA
) GFCI	Receptacle	21960 VA	72.77%	15980 VA	TOTAL EST. DEMAND (A):	164 A
5) AFCI (DED. NEUTRAL REQ'D)	Misc Equip	29067 VA	100.00%	29067 VA		
EXISTING CIRCUIT TO REMAIN						700
) THROUGH RELAY PANEL						
) THROUGH LIGHTING INVERTER						

PATRICK FAGUE-28837 STORMWATER MAINTENANCE AND OPERATIONS BUILDING

PROJECT NO. SW23-01-01

CITY OF TULSA, OKLAHOMA WATER AND SEWER DEPARTMENT

PLANS AND ESTIMATES PREPARED BY:

BKL, INCORPORATED ENGINEERS & ARCHITECTS

GREEN ACORN MECHANICAL, ELECTRICAL & PLUMBING

		- 1		PLAN SCALE:	DRAWN	DR	APPROVED
Ю	REVISION	BY	DATE		DESIGNED		
	Addendum 2		8/7/2025		SURVEY		
				PROFILE SCALE	PROJ. MGR.		
_					LEAD ENGR.		
-		-	-	HORIZONTAL:	FIELD MGR.		
				VERTICAL:	RECOMMENDED	):	750
		_	-		DESIGN MANAG		O CITY ENGINEER
				FILE:	DRAWI	NG:	DATE:
			ATLAS PAGE NO:				
				SHEET NAME: ELECTR	ICAL SCH	IEDULE	S E6-01
	L		1				1

						LIGHT F	XTURE SCHEDULE	
TAG	MANUFACTURER	CATALOG NUMBER	VOLTAGE	WATTAGE	LIGHT SOURCE	MOUNTING	FINISH	DESCRIPTION
	METALUX	24CZ2-40-UNV-L840-CD1-U	120V	30 W	LED, 4000K	CEILING, RECESSED	WHITE	2X4 RECESSED, 4000L
	METALUX	24CZ2-40-UNV-EL10W-L840-CD1-U	120V	30 W	LED, 4000K	CEILING, RECESSED	WHITE	2X4 RECESSED, 4000L, INTEGRAL BATTERY
	METALUX	22CZ2-32-UNV-L840-CD1-U	120V	24 W	LED, 4000K	CEILING, RECESSED	WHITE	2X2 RECESSED, 3200L
	METALUX	22C72-32-UNV-EL10W-L840-CD1-U	120V	24 W	LED, 4000K	CEILING, RECESSED	WHITE	2X2 RECESSED, 3200L, INTEGRAL BATTERY
	PORTFOLIO	LD4C209040D010M1H	120V	23 W	LED, 4000K	CEILING, RECESSED	SEMI-SPECULAR	4" LED DOWNLIGHT, 2000L
	PORTFOLIO	LD4C209040D010M1H-IEM7	120V	23 W	LED, 4000K	CEILING, RECESSED	SEMI-SPECULAR	4" LED DOWNLIGHT, 2000L, INTEGRAL BATTERY
	PORTFOLIO	LD6C259040D010M1H	120V	32 W	LED, 4000K	CEILING, RECESSED	SEMI-SPECULAR	6" LED DOWNLIGHT, 2500L
		LD6C259040D010M1H-IEM7	120V	32 W	LED, 4000K	CEILING, RECESSED	SEMI-SPECULAR	6" LED DOWNLIGHT, 2500L, INTEGRAL BATTERY
	EVENLITE	MM-EM-20-BK-W-SD	120V	20 W	LED	RE: LIGHTING PLAN KEYNOTES	BLACK	20W LED MULLION MOUNTED EMERGENCY FIXTURE, LOCATE REMOTE DRIVER IN NEAREST ACCESSIBLE CEILING SPACE, FIXTURE SHALL BE MOUNTED TO MULLION DIRECTLY ABOVE DOOR, FIXTURE SHALL ONLY OPERATE IF POWER IS LOST TO BUILDING.
E .	LUMARK	TCRS-8W-M-BK	120V	8 W	LED, 4000K	STRUCTURE, SURFACE	BLACK	8W LED SPOT LIGHT MOUNTED DIRECTLY TO JUNCTION BOX.
		BPRO3-REC-FLSH-LED4-MO-(R7' 2-1/4") - TMW-SAL-WTW-SC-UNV-X7-DM01	120V	39 W	LED, 4000K	RECESSED, CEILING	WHITE	5.6W/FT, 700L/FT RECESSED LINEAR FIXTURE (7° 2-1/4" LENGTH). WALL TO WALL CONFIGURATION. PROVIDE FIELD CUTTABLE FILLER FIXTURE.
	PRUDENTIAL	BPRO3-REC-FLSH-LED4-MO-(R15' 5-1/4") - TMW-SAL-WTW-SC-UNV-X7-DM01	120V	87 W	LED, 4000K	RECESSED, CEILING	WHITE	5.6W/FT, 700L/FT RECESSED LINEAR FIXTURE (15' 5-1/4" LENGTH), WALL TO WALL CONFIGURATION. PROVIDE FIELD CUTTABLE FIXTURE.
	PRUDENTIAL	BPRO3-REC-FLSH-LED4-MO-(R20' 3/8") - TMW-SAL-WTW-SC-UNV-X7-DM01-(3)EMHE	120V	112 W	LED, 4000K	RECESSED, CEILING	WHITE	5.6W/FT, 700L/FT RECESSED LINEAR FIXTURE (23' 3/8" LENGTH). WALL TO WALL CONFIGURATION. PROVIDE FIELD CUTTABLE FIXTURE. PROVIDE (3) EM AS INDICATED ON PLANS.
	PRUDENTIAL	BPRO3-LIN-FLSH-LED4-MO/SO-6'-TMW-SAL-HCW-ADC-SC-UNV-CA48"-X1-DM01	120V	80 W	LED, 4000K	CEILING, PENDANT +84"	WHITE	6' LED UP/DOWN PENDANT FIXTURE
	PRUDENTIAL	BPRO3-LIN-FLSH-LED4-MO/SO-8'-TMW-SAL-HCW-ADC-SC-UNV-CA48"-X1-DM01	120V		LED, 4000K	CEILING, PENDANT +84"	WHITE	8' LED UP/DOWN PENDANT FIXTURE
	NEO-RAY	SA212DIP-C675D530U840-C20-JB-20F0-1-UDD-F-4-F-D-S2A2	120V	206 W	LED, 4000K	CEILING, PENDANT +144"	ACACIA	20' LED PENDANT FIXTURE, 675 LM/FT DOWN, 530 LM/FT UP, 20' AIRCRAFT CABLE MOUNT
	NEO-RAY A	SA212DIP-C675D530U840-C20-JB-24F0-1-UDD-F-4-F-D-S2A2	120V	247 W	LED, 4000K	CEILING, PENDANT +144"	ACACIA	24' LED PENDANT FIXTURE, 675 LM/FT DOWN, 530 LM/FT UP, 20' AIRCRAFT CABLE MOUNT
		SA212DIP_C675D530U840-C20-JB-40F0-1-(B3 PER PLANS)-UDD-F-4-F-D-S2A2	120V	412 W	LED, 4000K	CEILING, PENDANT +120"	ACACIA	40' LED PENDANT FIXTURE, 675 LWFT DOWN, 530 LWFT UP, 20' AIRCRAFT CABLE MOUNT, PROVIDE EM AS INDICATED ON PLANS.
S4 S4	/ /	LP3.5SMBWL-S4-MED/80/4000-V05-EXT-SB-UNV-N	120V	34 W	LED, 4000K	CANOPY, SURFACE	BLACK	4' SURFACE MOUNTED LINEAR FIXTURE, 870LMFT
S4E		LP3.5SMBWL-S4-MED/80/4000-V05-EXT-SB-UNV-EMB/1-N	120V	34 W	LED, 4000K	CANOPY, SURFACE	BLACK	4' SURFACE MOUNTED LINEAR FIXTURE, 870LWFT, BATTERY BACKUP
S8		LP3.5SMBWL-S8-MED/80/4000-V05-EXT-SB-UNV-N	120V	67 W	LED, 4000K	CANOPY, SURFACE	BLACK	8' SURFACE MOUNTED LINEAR FIXTURE, 870LMFT
	METALUX	45NX 415L+C-UNV-L840-CD-1-U	120V	26 W	LED, 4000K	CEILING, CHAIN HUNG, +108"	WHITE	4' LED STRIP LIGHT 4100L (6.5W/FT)
	METALUX	4SNX-41SL-LC-UNV-L840-CD-1-EL7W-U	120V	26 W	LED, 4000K	CEILING, CHAIN HUNG, +108"	WHITE	4' LED STRIP LIGHT 4100L, INTEGRAL BATTERY
	MCGRAW-EDISON	GALN-SA4A-740-U-T4FT-BK-HSS	120V	121 W	LED, 4000K	20' POLE (3' BASE)	BLACK	18000 LUMEN LED POLE LIGHT (PROVIDE 20' SQUARE POLE AND 3' POLE BASE)
	LUMARK	PRV-P-PA1A-740-T4W-WM-BK	120V	36 W	LED, 4000K	WALL, SURFACE +120"	BLACK	WALL MOUNTED LED FIXTURE WITH WALL MOUNT BRACKET. ENSURE JUNCTION BOX IS RECESSED WITHIN WALL CAVITY.
	LUMARK	PRV-P-PA1A-740-T4W-WM-BK-CBP	120V	36 W	LED, 4000K	WALL, SURFACE +120"	BLACK	WALL MOUNTED LED FIXTURE WITH WALL MOUNT BRACKET AND EMERGENCY BATTERY BACKUP. ENSURE JUNCTION BOX IS RECESSED WITHIN WALL CAVITY.
	PRUDENTIAL	BIO-PSTD-FLSH-LED4-MO-R22-AWW-D1G-LP-SC-UNV-X7BF-DM01	120V	154 W	LED, 4000K	CEILING, RECESSED	WHITE	22' WALL WASH LED FIXTURE, 550 LM/FT
	PORTFOLIO	LD4C109040D010LSWW1H	120V	10 W	LED, 4000K	CEILING, RECESSED	SEMI-SPECULAR	4" LED WALL WASH DOWNLIGHT, 1000L
	SURE-LITES	ARCEL71RCSSSD	120V	2W	LED, RED	CEILING, SURFACE	BRUSHED ALUMINUM	LED RED EXIT SIGN, SINGLE FACE, CEILING MOUNT, BATTERY BACKUP
	SURE-LITES	ARCEL71R0000D	120V	2W	LED, RED	CEILING, SURFACE	BRUSHED ALUMINUM	LED RED EXIT SIGN, DOUBLE FACE, CEILING MOUNT, BATTERY BACKUP
	SURE-LITES	ARCEL71RCSSSD	120V	2W	LED, RED	WALL, SURFACE +90"	BRUSHED ALUMINUM	LED RED EXIT SIGN, SINGLE FACE, WALL MOUNT, BATTERY BACKUP

				LIGHTING CONTROLS SCHEDULE
ROOM INFO		REMARKS	SWITCH	ZONE DESCRIPTION
NAME NUMBER		INDICATOR	A STATE OF THE STA	
CORR.	120	2,3	а	CORRIDOR 120, 127, 133, AND 150 LIGHTING. TIMECLOCK SHALL CONTROL LIGHTS DURING NORMAL OPERATIONAL HOURS, IR OCCUPANCY SENSORS SHALL ALLOW AFTER HOURS CONTROL OF LIGHTS. PROVIDE MANUAL WALL SWITCH FOR OVERRIDE OF TIMECLOCK/OCCUPANCY SENSOR.
CORRIDOR	127	2,3	а	CORRIDOR 120, 127, 133, AND 150 LIGHTING, CORRIDOR 120, 127, 133, AND 150 LIGHTING, TIMECLOCK SHALL CONTROL LIGHTS DURING NORMAL OPERATIONAL HOURS, IR OCCUPANCY SENSORS SHALL ALLOW AFTER HOURS CONTROL OF LIGHTS, PROVIDE MANUAL WALL SWITCH FOR OVERRIDE OF TIMECLOCK/OCCUPANCY SENSOR.
CORR.	133	2,3	a	CORRIDOR 120, 127, 133, AND 150 LIGHTING, CORRIDOR 120, 127, 133, AND 150 LIGHTING, TIMECLOCK SHALL CONTROL LIGHTS DURING NORMAL OPERATIONAL HOURS, IR OCCUPANCY SENSORS SHALL ALLOW AFTER HOURS CONTROL OF LIGHTS, PROVIDE MANUAL WALL SWITCH FOR OVERRIDE OF TIMECLOCK/OCCUPANCY SENSOR.
OPEN OFFICES	150	2,3	а	CORRIDOR 120, 127, 133, AND 150 LIGHTING.CORRIDOR 120, 127, 133, AND 150 LIGHTING.CORRIDOR 120, 127, 133, AND 150 LIGHTING. CORRIDOR 120, 127, 133, AND 150 LIGHTING. TIMECLOCK SHALL CONTROL LIGHTS DURING NORMAL OPERATIONAL HOURS. IR OCCUPANCY SENSORS SHALL ALLOW AFTER HOURS CONTROL OF LIGHTS. PROVIDE MANUAL WALL SWITCH FOR OVERRIDE OF TIMECLOCK/OCCUPANCY SENSOR.
OPEN OFFICES	121	1	b	OPEN OFFICE 150 LINEAR PENDANT FIXTURES, ZONE SHALL BE 0-10V DIMMABLE FROM SWITCH, SWITCH MUST HAVE THE ABILITY TO CONTROL (2) SEPARATE CIRCUITS.
OPEN OFFICES-2	150-2	1	c	OPEN OFFICE 150 LINEAR PENDANT FIXTURES. ZONE SHALL BE 0-10V DIMMABLE FROM SWITCH, SWITCH MUST HAVE THE ABILITY TO CONTROL (3) SEPARATE CIRCUITS.
WOMENS	154	2	d	WOMENS 155 LIGHTING, ZONE SHALL BE EQUIPPED WITH DUAL TECHNOLOGY OCCUPANCY SENSORS.
MENS	153	2	f	MENS 154 LIGHTING, ZONE SHALL BE EQUIPPED WITH DUAL TECHNOLOGY OCCUPANCY SENSORS.
RECEPTION	117	1	a	RECEPTION AREA PENDANT LIGHTING, ZONE SHALL BE 0-10V DIMMABLE FROM SWITCH, ZONE SHALL BE EQUIPPED WITH IR OCCUPANCY SENSORS.
RECEPTION	117	1	h	RECEPTION DESK TROFFER LIGHTING, ZONE SHALL BE 0-10V DIMMABLE FROM SWITCH.
CORR.	109	2,3	j	CORRIDOR 193 AND 110 LIGHTING. TIMECLOCK SHALL CONTROL LIGHTS DURING NORMAL OPERATIONAL HOURS, IR OCCUPANCY SENSORS SHALL ALLOW AFTER HOURS CONTROL OF LIGHTS, PROVIDE MANUAL WALL SWITCH FOR OVERRIDE OF TIMECLOCK/OCCUPANCY SENSOR.
CORR.	110	2,3	j	CORRIDOR 109 AND 110 LIGHTING. TIMECLOCK SHALL CONTROL LIGHTS DURING NORMAL OPERATIONAL HOURS, IR OCCUPANCY SENSORS SHALL ALLOW AFTER HOURS CONTROL OF LIGHTS, PROVIDE MANUAL WALL SWITCH FOR OVERRIDE OF TIMECLOCK/OCCUPANCY SENSOR.
CORR.	110	1,2,3	k	BREAK ROOM LICHTING. ZONE SHALL BE 0-10V DIMMABLE FROM SWITCH, TIMECLOCK SHALL CONTROL LIGHTS DURING NORMAL OPERATIONAL HOURS, IR OCCUPANCY SENSORS SHALL ALLOW AFTER HOURS CONTROL OF LIGHTS, PROVIDE MANUAL WALL SWITCH FOR OVERRIDE OF TIMECLOCK/OCCUPANCY SENSOR.
WOMENS	112B	2	m	WOMENS 112A AND 112B LIGHTING, ZONE SHALL BE EQUIPPED WITH DUAL TECHNOLOGY OCCUPANCY SENSORS, SWITCH SHALL BE LOCATED IN WOMENS 112B
LOBBY	100		n	LOBBY AND PREFUNCTION LIGHTING, ON/OFF CONTROL ONLY.
CORR.	109	_	n	LOBBY AND PREFUNCTION LIGHTING, ON/OFF CONTROL ONLY.
MENS	113B	2	0	MENS 113A AND 113B LIGHTING, ZONE SHALL BE EQUIPPED WITH DUAL TECHNOLOGY OCCUPANCY SENSORS, SWITCH SHALL BE LOCATED IN MENS 113B
TRAINING	104	1,2	P	EAST TRAINING LINEAR LIGHTING, ZONE SHALL BE 0-10V DIMMABLE FROM SWITCH, ZONE SHALL BE EQUIPPED WITH IR OCCUPANCY SENSORS AND SENSORS SHALL CONTROL ON/OFF OF BOTH ZONE 1/2 AND ZONE Y.
TRAINING	104	1,2	r	WEST TRAINING DOWNLIGHTING, ZONE SHALL BE 0-10V DIMMABLE FROM SWITCH, ZONE SHALL BE EQUIPPED WITH IR OCCUPANCY SENSORS AND SENSORS SHALL CONTROL ON/OFF OF BOTH ZONE 'Y AND ZONE 'S'.
TRAINING	104	1,2	s	WEST TRAINING LINEAR LIGHTING, ZONE SHALL BE 0-10V DIMMABLE FROM SWITCH, ZONE SHALL BE EQUIPPED WITH IR OCCUPANCY SENSORS AND SENSORS SHALL CONTROL ON/OFF OF BOTH ZONE 'Y AND ZONE 's'.
TRAINING	104	1.2	t	EAST TRAINING DOWNLIGHTING, ZONE SHALL BE 0-10V DIMMABLE FROM SWITCH. ZONE SHALL BE EQUIPPED WITH IR OCCUPANCY SENSORS AND SENSORS SHALL CONTROL ON/OFF OF BOTH ZONE 'P' AND ZONE Y.
CONF.	149	1,2	w	CONF 149 PERIMETER LIGHTING, ZONE SHALL BE 0-10V DIMMABLE FROM SWITCH, ZONE SHALL BE EQUIPPED WITH IR OCCUPANCY SENSORS AND SENSORS SHALL CONTROL ON/OFF OF BOTH ZONE W AND ZONE X.
CONF.	149	1,2	×	CONF 149 PENDANT LIGHT, ZONE SHALL BE 0-10V DIMMABLE FROM SWITCH, ZONE SHALL BE EQUIPPED WITH IR OCCUPANCY SENSORS AND SENSORS SHALL CONTROL ON/OFF OF BOTH ZONE W AND ZONE Y.

- REMARKS:
  1. CONTROLS TO BE EQUIPPED WITH 0-10V DIMMING
  1. PROVIDE CEILING MOUNTED OCCUPANCY SENSORS WITH FULL ROOM COVERAGE, OCCUPANCY SENSORS SET TO 20 MINUTE SHUTOFF, SENSOR LOCATIONS ARE SHOWN FOR REFERENCE ONLY AND CAN BE MODIFIED BASED ON COVERAGE RANGE OF SUBMITTED PRODUCT.
  3. LIGHTING ZONE SHALL HAVE TIMECLOCK FUNCTION THAT OPERATES FROM OPEN-CLOSE OF BUSINESS HOURS (VERIFY OPERATIONAL HOURS WITH OWNER PRIOR TO PROGRAMMING)

- GENERAL NOTES:

  ALL EXTERIOR LIGHTING ZONES SHALL BE EQUIPPED WITH TIMECLOCK FUNCTION THAT OPERATES DUSK-DAWN. PROVIDE ADDITIONAL PHOTOCELL FOR EXTERIOR LIGHTING CIRCUITS FOR OVERRIDE OF DUSK-DAWN PROGRAMMING. EXTERIOR LIGHTING CONTROL MAY BE PROVIDED BY A LIGHTING CONTACTOR RATHER THAN DISTRIBUTED WIREDWIRELESS CONTROLS.

  UTILIZE SWITCHES THAT ALLOW FOR MULTI-ZONE CONTROL WHERE POSSIBLE. WHERE MULTIPLE ADJACENT SWITCHES ARE SHOWN ON PLANS, CONSOLIDATE TO AS FEW PHYSICAL SWITCHES AS POSSIBLE WHILE ALLOWING FOR PULL FUNCTIONALITY AS INDICATED IN THE CONTROLS SCHEDULE.

  REFER TO PLANS FOR LIGHTING CONTROL ZONE EXTENTS.

#### LIGHTING CONTROL NOTES

THE DESIGN OF THE LIGHTING CONTROLS CONTAINED WITHIN THIS DRAWING SET SHALL BE CONSTRUED AS A PERFORMANCE-BASED SPECIFICATION. AT THE CONTRACTOR'S OPTION THE DESIGNED SYSTEM MAY BE SUBMITTED, OR A SUBSTITUTION OF THE CONTRACTOR'S DESIGN MAY BE PROVIDED. THE PERFORMANCE OF THE SYSTEM SHALL MEET ALL THE REQUIREMENTS AS SHOWN IN THE DRAWINGS AND BE INSTALLED IN A MANNER THAT COMPLIES WITH IECC 2006. CONTRACTOR SHALL BE RESPONSIBLE FOR PROVIDING A COMPLETELY FUNCTIONAL LIGHTING CONTROL SYSTEM AND SHALL FURNISH ALL LABOR, MATERIALS, AND EQUIPMENT REQUIRED FOR THAT SYSTEM. IF THE CONTRACTOR OPTS TO USE A DESIGN SUBSTITUTION, THE SYSTEM SHALL CONSIST OF A COMBINATION OF RELAY PANEL BASED CONTROLS, DISTRIBUTED WIRED CONTROLS, DISTRIBUTED WIRED CONTROLS, DISTRIBUTED WIRED CONTROLS, AND/OR LOCAD, CONTROLS, SHALL BE PROVIDED AND MAY INCLUDE: ACUITY CONTROLS, COOPER CONTROLS, SENSORWORX, SYNAPSE, WATTSTOPPER. ALL TIME-BASED CONTROLS SHALL USE A SINGLE TIME CLOCK SOURCE TO ENSURE UNIFORM TRANSITIONS. SUBSTITUTE CONTROLS SHALL BE DESIGNED TO BE AS SIMPLE AS POSSIBLE FOR END USER USE AND MANIFEMANCE. SUBSTITUTIONS REQUIRING NUMBEROUS MANUFACTURERS OR SYSTEM TYPES WILL BE REJECTED. ENGINEER RESERVES THE RIGHT TO REJECT ANY SUBSTITUTIONS AND REQUIRE RESUBMITTAL WITH NO COST CHANGE TO OWNER.

STORMWATER MAINTENANCE AND OPERATIONS BUILDING PROJECT NO. SW23-01-01

> CITY OF TULSA, OKLAHOMA WATER AND SEWER DEPARTMENT

PLANS AND ESTIMATES PREPARED BY:

BKL, INCORPORATED **ENGINEERS & ARCHITECTS** 

GREEN ACORN MECHANICAL, ELECTRICAL & PLUMBING

			PLAN SCALE:	DRAWN	DB		APPROVED			
REVISION	BY	DATE		DESIGNED			]			
Addendum 2		8/7/2025		SURVEY						
			PROFILE SCALE	PROJ. MGR.						
				LEAD ENGR.			1			
			HORIZONTAL: VERTICAL:	FIELD MGR.			1.0			
				RECOMMENDED:  DESIGN MANAGER  DRAWING: FOR			CITY ENGINEER			
			FILE:				DATE: U			
			ATLAS PAGE NO:							
			SHEET NAME: ELECTR	ICAL SCI	E6-03					
		restricted .	1.00110101	REVISION	REVISION BY DATE Addendum 2  8/7/2025  PROFILE SCALE PROJ. MGR. LEAD ENGR. HORIZONTAL: FIELD MGR. RECOMMENDED VERTICAL: DESIGN MANAG FILE: DRAWI ATLAS PAGE NO: SHEET MANE:	DESIGNED   DATE   DESIGNED   SURVEY   SURVEY   PROFILE SCALE   PROJ. MGR   LEAD ENGR.   FIELD MGR.   RECOMMENDED:   DESIGN MANAGER   FILE: DESIGN MANAGER   TALES PAGE NO:   SHEET NAME:   PROJ. MGR.   PROMING:   PROMING	DESIGNED   DESIGNED   SURVEY   SURVEY			